

SITE DATA TABLE	
PIN	ROS413-015-005-000
OWNER	DTSC, LLC
OWNER ADDRESS	401 CHESTNUT ST, SUITE A WILMINGTON, NC 28401
SITE ADDRESS	102 WRIGHT ST. WILMINGTON, NC 28401
ZONING	UMK URBAN MIXED USE
CURRENT LAND USE	VACANT
ACREAGE	80,213 SF = 1.84 AC.
REQUIRED SETBACKS	0' - ALL SIDES
EXISTING BLDG.	0
EX. GRAVEL DRIVE	10,500 SF
TOTAL EX. IMPERVIOUS	10,500 SF
EX. IMPERVIOUS TO BE REMOVED	10,500 SF
REMAINING EX. IMPERVIOUS	0 SF
PROPOSED UNITS	4 3-STORY UNITS
INFORMATION PER UNIT	
TOTAL BUILDING FOOTPRINT	4,186 SF
BUILDING HEIGHT	34'
COMMERCIAL SPACE	4800 SF
2-BEDROOM UNITS	5
1-BEDROOM UNITS	3
STUDIO UNITS	8
TOTAL PROJECT BEDROOMS	21
SF PER FLOOR	4,186 SF
TOTAL BUILDING SF (FOOTPRINT)	16,744 SF
IMPERVIOUS PAVEMENT	14,800 SF
CONCRETE SIDEWALK	2,175 SF
CONCRETE CURB AND GUTTER	3,514 SF
TOTAL IMPERVIOUS	37,343 SF
PERVIOUS CONCRETE (PARKING)	13,880 SF
LOT COVERAGE/PROP. BUILT-UPON AREA	37,343 SF = 86 AC = 63.9%
TOTAL PARKING SPACES PROVIDED	(4) 2 REGULAR / 2 VAN SPACES
BICYCLE PARKING REQUIRED/PROVIDED	4/20
DISTURBED AREA	85,620 SF = 1.97 AC.
BUILDING CONSTRUCTION TYPE	WOOD FRAMED, NC TYPE V-B
CAMA LAND USE DESIGNATION	URBAN
ESTIMATED TRIP GENERATION	
RESIDENTIAL	422 TOTAL, 280AM PEAK, 378PM PEAK
COMMERCIAL - GENERAL OFFICE	26 TOTAL, 40AM PEAK, 48PM PEAK
COMMERCIAL - RETAIL	106 TOTAL, 168AM PEAK, 78PM PEAK
DEVELOPED AREA	70,485 SF = 1.6 AC.

1. THIS PROPERTY LIES INSIDE THE 1945 CORPORATE LIMITS.
2. THERE ARE NO CONSERVATION RESOURCES ON THE SITE.
3. THERE ARE NO LOCAL, STATE OR FEDERALLY RECOGNIZED HISTORIC STRUCTURES OR ARCHAEOLOGICAL RESOURCES ON THIS SITE.
4. THERE ARE NO WETLANDS ON THIS SITE.
5. NO ENDANGERED SPECIES OR CRITICAL HABITAT OCCUR ON THIS SITE.
6. EXISTING SIDEWALK ON MEARES ST. NO ADDITIONAL TRANSIT FACILITIES EXIST.
7. ALL UTILITY AND EQUIPMENT WILL BE CONTAINED ON THE SITE.
8. ALL PERIMETER SIDEWALKS TO BE 4' WIDE TO BE CONSISTENT WITH EXISTING SIDEWALKS ON THE BLOCK.
9. INTERIOR SIDEWALKS TO BE 4' WIDE.
10. PERVIOUS CONCRETE PARKING IS GETTING 100% PERVIOUS CREDIT.

SURVEY BY HANOVER DESIGN SERVICE, P.A.  
1123 FARM PARKWAY  
WILMINGTON, NC 28403



**CITY OF WILMINGTON**  
NORTH CAROLINA  
Public Services • Engineering Division  
APPROVED STORMWATER MANAGEMENT PLAN  
Date: \_\_\_\_\_ Permit # \_\_\_\_\_  
Signed: \_\_\_\_\_

**Approved Construction Plan**

Name \_\_\_\_\_ Date \_\_\_\_\_

Planning \_\_\_\_\_


Traffic \_\_\_\_\_

Fire \_\_\_\_\_

LINE LEGEND	
	PROPERTY LINE
	ADJACENT PROPERTY LINE
	PRIVACY FENCE
	PERVIOUS CONCRETE DRAINAGE AREA
	DRAINAGE AREA

**TREE RETENTION, REMOVAL AND PLANTINGS**  
1.6 ACRES DEVELOPED, 1.6 X 15 TREES PER ACRE = 24 TREES REQUIRED  
58 TOTAL NEW TREES PROVIDED / 28 NEW TREES EXCLUDING STREETYARD

- ON-SITE TREES**  
THREE DEAD TREES TO BE REMOVED: (2) 18" OAKS, (1) 14" OAK  
SIGNIFICANT TREES REMOVED: (1) 25" OAK  
REGULATED TREES TO BE REMOVED:  
21" OAK: 2  
17" OAK: 1  
15" OAKS: 2  
14" OAKS: 3  
12" OAKS: 2  
10" OAK: 1  
8" OAK: 1  
REGULATED TREES TO BE PRESERVED:  
22" OAKS: 2 CREDIT: 8  
20" OAKS: 2 CREDIT: 8  
19" OAKS: 2 CREDIT: 8  
18" OAKS: 3 CREDIT: 12  
17" OAKS: 2 CREDIT: 6  
12" OAKS: 3 CREDIT: 9  
11" OAKS: 2 CREDIT: 4  
10" OAKS: 2 CREDIT: 4  
9" OAKS: 3 CREDIT: 6  
8" OAKS: 3 CREDIT: 6  
11" PECAN: 1 CREDIT: 2  
ADDITIONAL TREES TO BE PRESERVED:  
6" OAKS: 1 CREDIT: 2  
TOTAL CREDITS: 75  
**OFF-SITE TREES**  
SIGNIFICANT TREES REMOVED: (1) 25" DISEASED ELM (PER AARON REESE)  
SIGNIFICANT TREES TO BE PRESERVED:  
26" OAK: 1  
25" OAK: 1  
DOCUMENTED TREES TO BE PRESERVED:  
17" OAKS: 2  
9" OAKS: 3

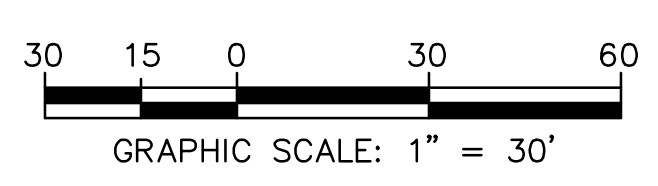

FOR REGULATORY REVIEW - NOT FOR CONSTRUCTION

REV. NO.	DESCRIPTION	DATE

102 WRIGHT STREET - OWNER: DTSC LLC  
**THE BLOCK ON FRONT**  
WILMINGTON NORTH CAROLINA  
NEW HANOVER COUNTY




EXISTING CONDITIONS, SITE  
INVENTORY & DEMOLITION

**RIGHT ANGLE**  
ENGINEERING, P.C.  
212 PRINCESS STREET  
WILMINGTON, NC 28401  
(910) 251-8544 FAX (910) 251-2208 FIRM: C-0829

DATE: 8/8/22  
Scale: 1"=30'  
Drawn: NNC  
Checked: WSL  
Project No: HA0121  
Sheet No: **C1**





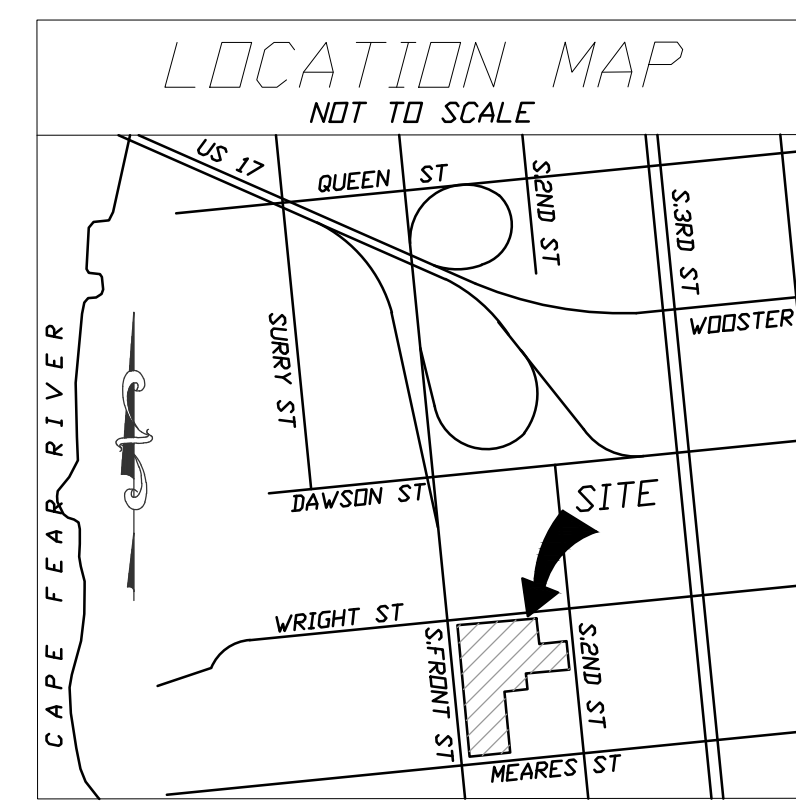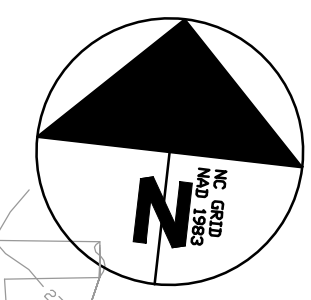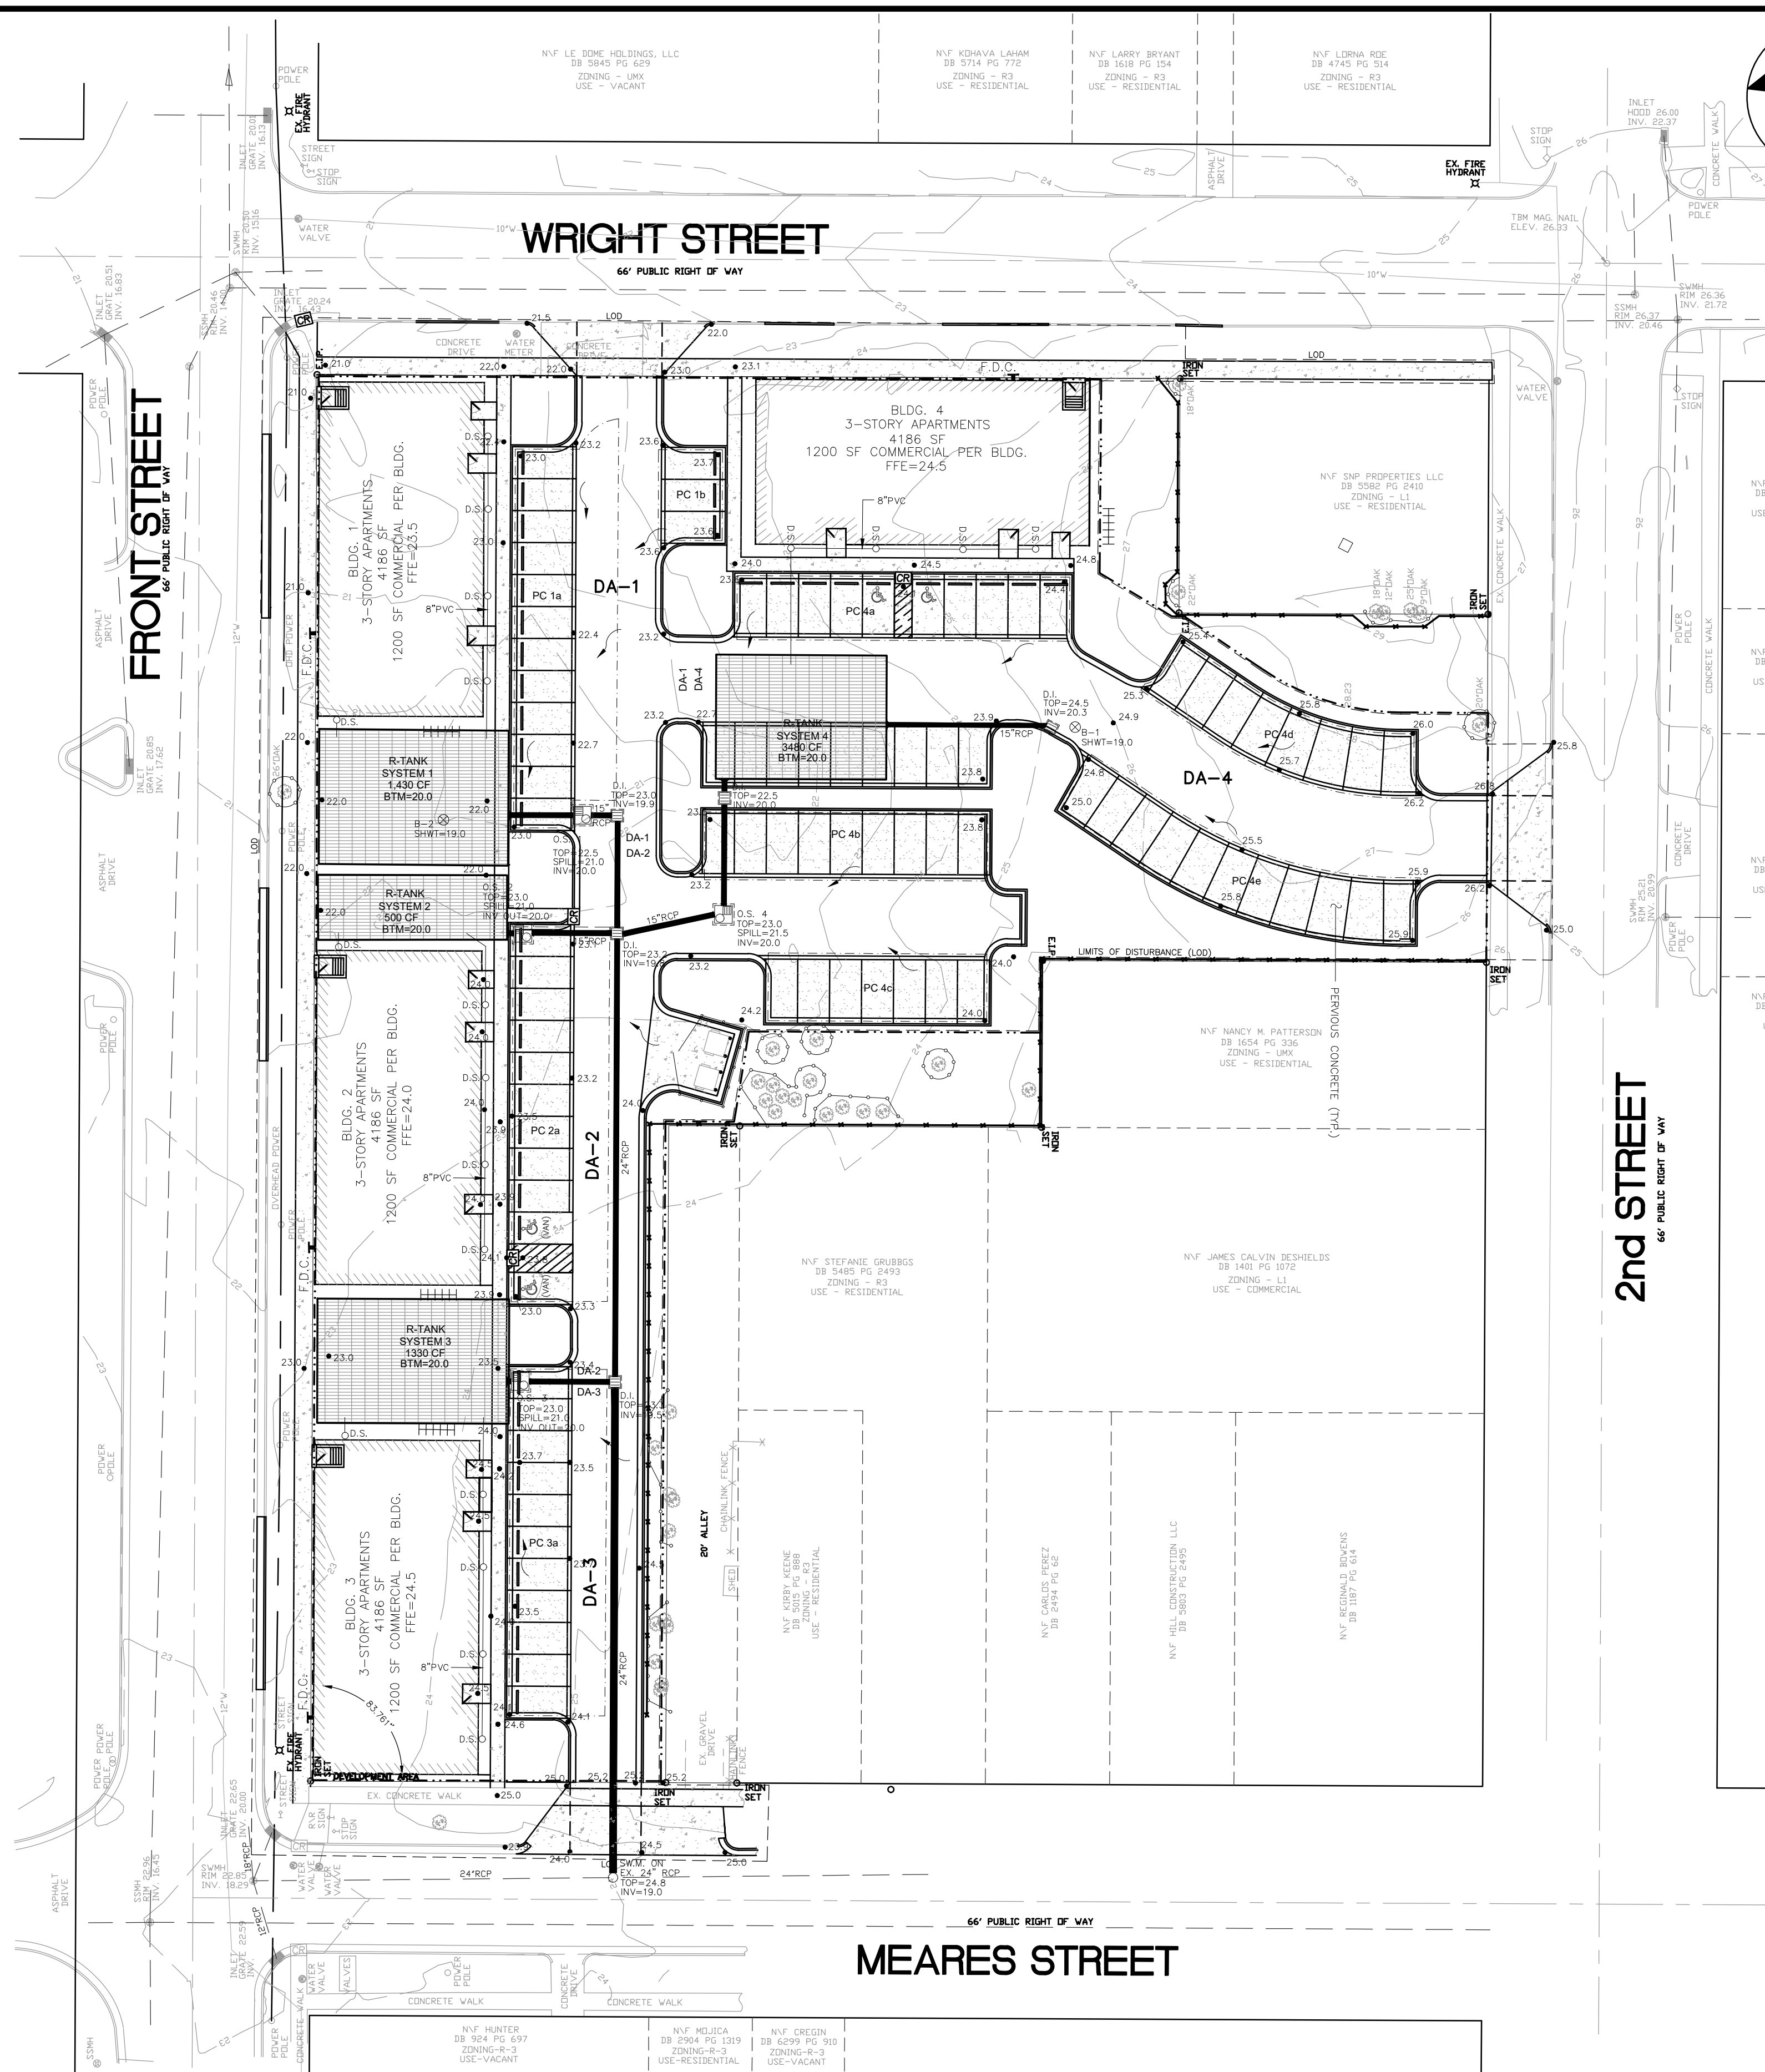

SITE DATA TABLE	
PN	RS413-015-005-000
OWNER	DTSC, LLC
OWNER ADDRESS	401 CHESTNUT ST., SUITE A
	WILMINGTON, NC 28401
SITE ADDRESS	WILMINGTON, NC 28401
ZONING	UMX - URBAN MIXED USE
CURRENT LAND USE	VACANT
ACREAGE	80,413 SF = 1.84 AC.
REQUIRED SETBACKS	0' - ALL SIDES
EXISTING BLDG.	0
EX. GRAVEL DRIVE	10,500 SF
TOTAL EX. IMPERVIOUS	10,500 SF
EX. IMPERVIOUS TO BE REMOVED	10,500 SF
REMAINING EX. IMPERVIOUS	0 SF
PROPOSED UNITS	4 3-STORY UNITS
INFORMATION PER UNIT	
TOTAL BUILDING FOOTPRINT	4,186 SF
BUILDING HEIGHT	34'
COMMERCIAL SPACE	4800 SF
2-BEDROOM UNITS	5
1-BEDROOM UNITS	3
STUDIO UNITS	6
TOTAL BEDS	21
TOTAL PROJECT BEDROOMS	84
SF PER FLOOR	4,186 SF
TOTAL BUILDING SF (FOOTPRINT)	16,744 SF
IMPERVIOUS PAVEMENT	14,900 SF
CONCRETE SIDEWALK	2,175 SF
CONCRETE CURB AND GUTTER	3,524 SF
TOTAL IMPERVIOUS	37,343 SF
PERVIOUS CONCRETE (PARKING)	13,880 SF
LOT COVERAGE/PROP. BUILT-UPON AREA	37,343 SF = .86 AC = 63.9%
TOTAL PARKING SPACES PROVIDED	81 (INCLUDING ADA)
ADA PARKING SPACES PROVIDED	(2) 2 REGULAR / 2 VAN SPACES
BICYCLE PARKING REQUIRED/PROVIDED	4/20
DISBURSED AREA	85,620 SF = 1.97 AC.
BUILDING CONSTRUCTION TYPE	WOOD FRAMED, NC TYPE V-B
CAMA LAND USE DESIGNATION	URBAN
ESTIMATED TRIP GENERATION	
RESIDENTIAL	422 TOTAL, 290AM PEAK, 370PM PEAK
COMMERCIAL - GENERAL OFFICE	28 TOTAL, 40AM PEAK, 40PM PEAK
COMMERCIAL - RETAIL	108 TOTAL, 108AM PEAK, 78PM PEAK
DEVELOPED AREA	70,485 SF = 1.6 AC.


- NOTES:
- THE CONSTRUCTION SITE IS NOT LOCATED IN A FEMA FLOOD HAZARDOUS ZONE.
  - FIRM # 3720311700K, JUNE 2, 2006
  - THERE ARE NO WETLANDS ON THE SITE.
  - PRIOR TO ANY CLEARING, GRADING OR CONSTRUCTION ACTIVITY, TREE PROTECTION FENCING SHALL BE INSTALLED AROUND PROTECTED TREES OR GROVES OF TREES. NO CONSTRUCTION WORKERS, TOOLS, MATERIALS, OR VEHICLES ARE PERMITTED WITHIN THE TREE PROTECTION FENCING.
  - ANY TREES AND/OR AREAS DESIGNATED TO BE PROTECTED MUST BE PROPERLY BARRICADED WITH FENCING AND PROTECTED THROUGHOUT CONSTRUCTION TO INSURE THAT NO CLEARING, GRADING OR STAGING OF MATERIALS WILL OCCUR IN THOSE AREAS.
  - NO EQUIPMENT IS ALLOWED ON SITE UNTIL ALL TREE PROTECTION FENCING AND SILT FENCING IS INSTALLED AND APPROVED. PROTECTIVE FENCING IS TO BE MAINTAINED THROUGHOUT THE DURATION OF THE PROJECT, AND CONTRACTORS SHALL RECEIVE ADEQUATE INSTRUCTION ON TREE PROTECTION METHODS.
  - TRAFFIC CONTROL DEVICES (INCLUDING SIGNS AND PAVEMENT MARKINGS) IN AREAS OPEN TO PUBLIC TRAFFIC ARE TO MEET MUTCD (MANUAL ON UNIFORM TRAFFIC CONTROL DEVICES) STANDARDS.
  - IF THE CONTRACTOR DESIRES WATER FOR CONSTRUCTION, HE SHALL APPLY IN ADVANCE FOR THIS SERVICE FROM CAPE FEAR PUBLIC UTILITY AUTHORITY (CFPUA) AND MUST PROVIDE A REDUCED PRESSURE ZONE (RPZ) BACKFLOW PREVENTION DEVICE ON THE DEVELOPER'S SIDE OF THE METER BOX. ANY BACKFLOW PREVENTION DEVICES REQUIRED WILL NEED TO BE ON THE LIST OF DEVICES APPROVED BY USCFCCOHR OR ASSE.
  - ANY IRRIGATION SYSTEM SUPPLY BY CFPUA WATER SHALL COMPLY WITH THE CFPUA CROSS CONNECTION CONTROL REGULATIONS.
  - CONTACT THE NORTH CAROLINA ONE CALL CENTER AT 1-800-632-4949 PRIOR TO DOING ANY DIGGING, CLEARING OR GRADING.
  - THE BELLSOUTH CONTACT IS STEVE DAYVAULT. HE IS THE BUILDING INDUSTRY CONSULTANT (910) 392-8712. PLEASE CONTACT HIM PRIOR TO STARTING THE PROJECT IN ORDER TO FACILITATE GOOD COMMUNICATION AND MAXIMUM FLEXIBILITY.
  - ALL PLANTED AND RETAINED LIVING MATERIAL REQUIRED TO MEET THE PROVISIONS OF THE CITY OF WILMINGTON LAND DEVELOPMENT CODE, SHALL BE PERPETUALLY PROTECTED AND MAINTAINED TO PROFESSIONAL ACCEPTED STANDARDS BY JOINT AND SEVERAL RESPONSIBILITY OF THE OWNER, TENANT AND RESPECTIVE AGENTS OF THE PROPERTY ON WHICH THE MATERIAL IS LOCATED.
  - ANY PLANT MATERIAL THAT WAS PREVIOUSLY INSTALLED ON THE SITE TO MEET THE PROVISIONS OF THE CITY OF WILMINGTON LAND DEVELOPMENT CODE THAT HAS NOT BEEN MAINTAINED MUST BE REPLACED.
  - AS PART OF THE FINAL ZONING INSPECTION FOR THIS PROJECT, A SURVEY OF THE SITE LANDSCAPING WILL BE CONDUCTED. PLANT MATERIAL THAT HAS NOT BEEN MAINTAINED MUST BE REPLACED BEFORE A FINAL ZONING APPROVAL IS ISSUED.
  - ALL PARKING STALL MARKINGS AND LANE ARROWS WITHIN THE PARKING AREAS SHALL BE WHITE.
  - ALL TRAFFIC CONTROL SIGNS AND MARKINGS OFF THE RIGHT-OF-WAY ARE TO BE MAINTAINED BY THE PROPERTY OWNER IN ACCORDANCE WITH MUTCD STANDARDS.
  - A RAIN/FREEZE SENSOR SHALL BE INSTALLED AS PART OF ANY IRRIGATION SYSTEM USED ON THE SITE.
  - CONTACT TRAFFIC ENGINEERING AT 910-341-7888 48 HOURS PRIOR TO ANY EXCAVATION IN THE RIGHT-OF-WAY TO ENSURE THAT ALL TRAFFIC SIGNAL FACILITIES AND EQUIPMENT ARE PROPERLY LOCATED.
  - A UTILITY CUT PERMIT IS REQUIRED FOR EACH OPEN CUT OF A CITY STREET. NOTE THIS ON THE PLAN AND CONTACT 341-5888 FOR MORE DETAILS. IN CERTAIN CASES AN ENTIRE RESURFACING OF THE AREA BEING OPEN CUT MAY BE REQUIRED.
  - TACTILE WARNING MATS WILL BE INSTALLED ON ALL WHEELCHAIR RAMPS.
  - CONTACT TRAFFIC ENGINEERING AT 910-341-7888 TO DISCUSS STREET LIGHTING OPTIONS.
  - ANY BACKFLOW PREVENTION DEVICES REQUIRED BY THE CFPUA WILL NEED TO BE ON THE LIST OF APPROVED DEVICES BY USCFCCOHR OR ASSE.
  - CONTRACTOR TO FIELD VERIFY EXISTING WATER AND SEWER SERVICE LOCATIONS, SIZES AND MATERIALS PRIOR TO CONSTRUCTION. ENGINEER TO BE NOTIFIED OF ANY CONFLICTS.
  - CONTRACTOR SHALL MAINTAIN ALL-WEATHER ACCESS FOR EMERGENCY VEHICLES AT ALL TIMES DURING CONSTRUCTION.
  - ALL PAVEMENT MARKINGS IN PUBLIC RIGHTS-OF-WAY AND FOR DRIVEWAYS ARE TO BE THERMOPLASTIC AND MEET CITY AND/OR NCDOT STANDARDS.
  - TRAFFIC ENGINEERING MUST APPROVE OF PAVEMENT MARKING PRIOR TO ACTUAL STRIPING.
  - ANY BROKEN OR MISSING SIDEWALK PANELS, DRIVEWAY PANELS AND CURBING WILL BE REPLACED.
  - PROJECT SHALL COMPLY WITH CFPUA CROSS CONNECTION CONTROL REQUIREMENTS. WATER METER(S) CANNOT BE RELEASED UNTIL ALL REQUIREMENTS ARE MET AND THE STATE HAS GIVEN THEIR FINAL APPROVAL. CALL 910-341-3911 FOR INFORMATION.
  - PARKING SPACES NOT REQUIRED FOR STORAGE FACILITIES. SIX ARE PROVIDED WITH TWO BEING ADA.
  - ALL NEW UTILITIES SHALL BE INSTALLED UNDERGROUND, EXCEPT WHERE SUCH PLACEMENT IS PROHIBITED OR DEEMED IMPRACTICAL BY THE UTILITY PROVIDER. UNDERGROUND TERMINAL FACILITIES FOR STREET LIGHTING ALONG ALL PUBLIC STREETS ABUTTING THE SUBJECT SITE SHALL BE INSTALLED BY THE DEVELOPER.
  - IMMEDIATELY NOTIFY CITY OF WILMINGTON TRAFFIC ENGINEERING AT 910-341-7888 IF ANY TRAFFIC SIGNAL FACILITIES OR CITY-OWNED STREETLIGHT FACILITIES ARE DAMAGED.
  - DAMAGED FACILITIES SHALL BE REPLACED BY AN APPROVED CONTRACTOR, ACCORDING TO STANDARD NCDOT REPLACEMENT SCHEDULES AND CURRENT NCDOT DESIGN STANDARDS.
  - ALL REPAIR/REPLACEMENT OF TRAFFIC SIGNAL INFRASTRUCTURE SHALL BE COORDINATED WITH THE CITY OF WILMINGTON TRAFFIC ENGINEERING DIVISION.
  - WATER AND SEWER SERVICES ARE NOT REQUIRED FOR THIS DEVELOPMENT.
  - UNDERGROUND FIRE LINE(S) MUST BE PERMITTED AND INSPECTED BY THE WILMINGTON FIRE DEPT. FROM PUBLIC RIGHT-OF-WAY TO THE BUILDING. CONTACT WILMINGTON FIRE DEPT. DIVISION OF FIRE AND LIFE SAFETY AT 910-341-0696.
  - NO OBSTRUCTIONS ARE PERMITTED IN THE SPACE BETWEEN THIRTY (30) INCHES AND TEN (10) FEET ABOVE THE GROUND WITHIN THE TRIANGULAR SIGHT DISTANCE.
  - EXISTING WATER AND SEWER BY CFPUA.
  - EXISTING STORMWATER SYSTEM BY CITY OF WILMINGTON.
  - SOLID WASTE DISPOSAL WILL NOT BE PROVIDED TO UNITS.

LINE LEGEND	
---	PROPERTY LINE
---	ADJACENT PROPERTY LINE
---	PRIVACY FENCE
---	PERVIOUS CONCRETE DRAINAGE AREA
---	DRAINAGE AREA

SYSTEM	STORAGE VOLUME	LENGTH	WIDTH	BOTTOM ELEV.	O.S. SPILLWAY ELEV.	MODULE HEIGHT
DA-1	1430 CF	53.3	38	20.0	21.0	1 (9.5")
DA-2	911 CF	53.3	18.3	20.0	21.0	1 (9.5")
DA-3	1423 CF	54	35	20.0	21.0	1 (9.5")
DA-4	2400 CF	48	35	20.0	21.5	2 (19")

**CITY OF WILMINGTON**  
NORTH CAROLINA  
Public Services • Engineering Division  
**APPROVED STORMWATER MANAGEMENT PLAN**  
Date: \_\_\_\_\_ Permit # \_\_\_\_\_  
Signed: \_\_\_\_\_

**Approved Construction Plan**  
Name: \_\_\_\_\_ Date: \_\_\_\_\_  
Planning  
Traffic  
Fire

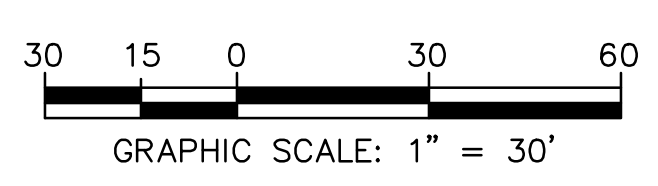

FOR REGULATORY REVIEW - NOT FOR CONSTRUCTION

REV. NO.	DESCRIPTION	DATE



**102 WRIGHT STREET - OWNER: DTSC LLC**  
**THE BLOCK ON FRONT**  
WILMINGTON NORTH CAROLINA  
NEW HANOVER COUNTY

**EROSION CONTROL, GRADING AND STORMWATER PLAN**

**RIGHT ANGLE ENGINEERING, P.C.**  
212 PRINCESS STREET  
WILMINGTON, NC 28401  
(910) 251-8544 FAX (910) 251-2208 FIRM: C-0829

DATE: 8/5/22  
Scale: 1"=30'  
Drawn: NNC  
Checked: WSL  
Project No: HA0121  
Sheet No: **C3**



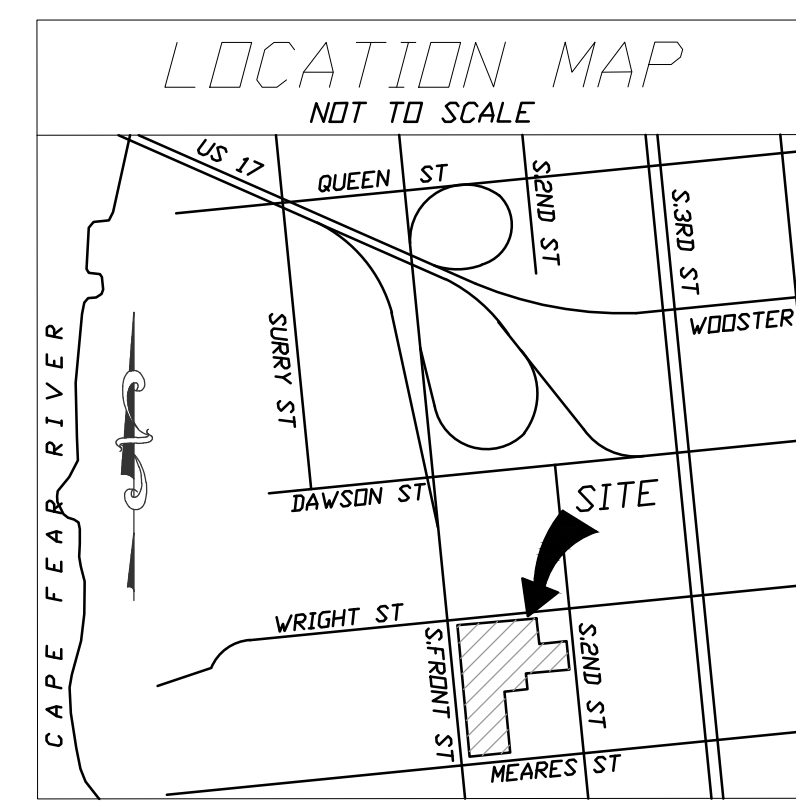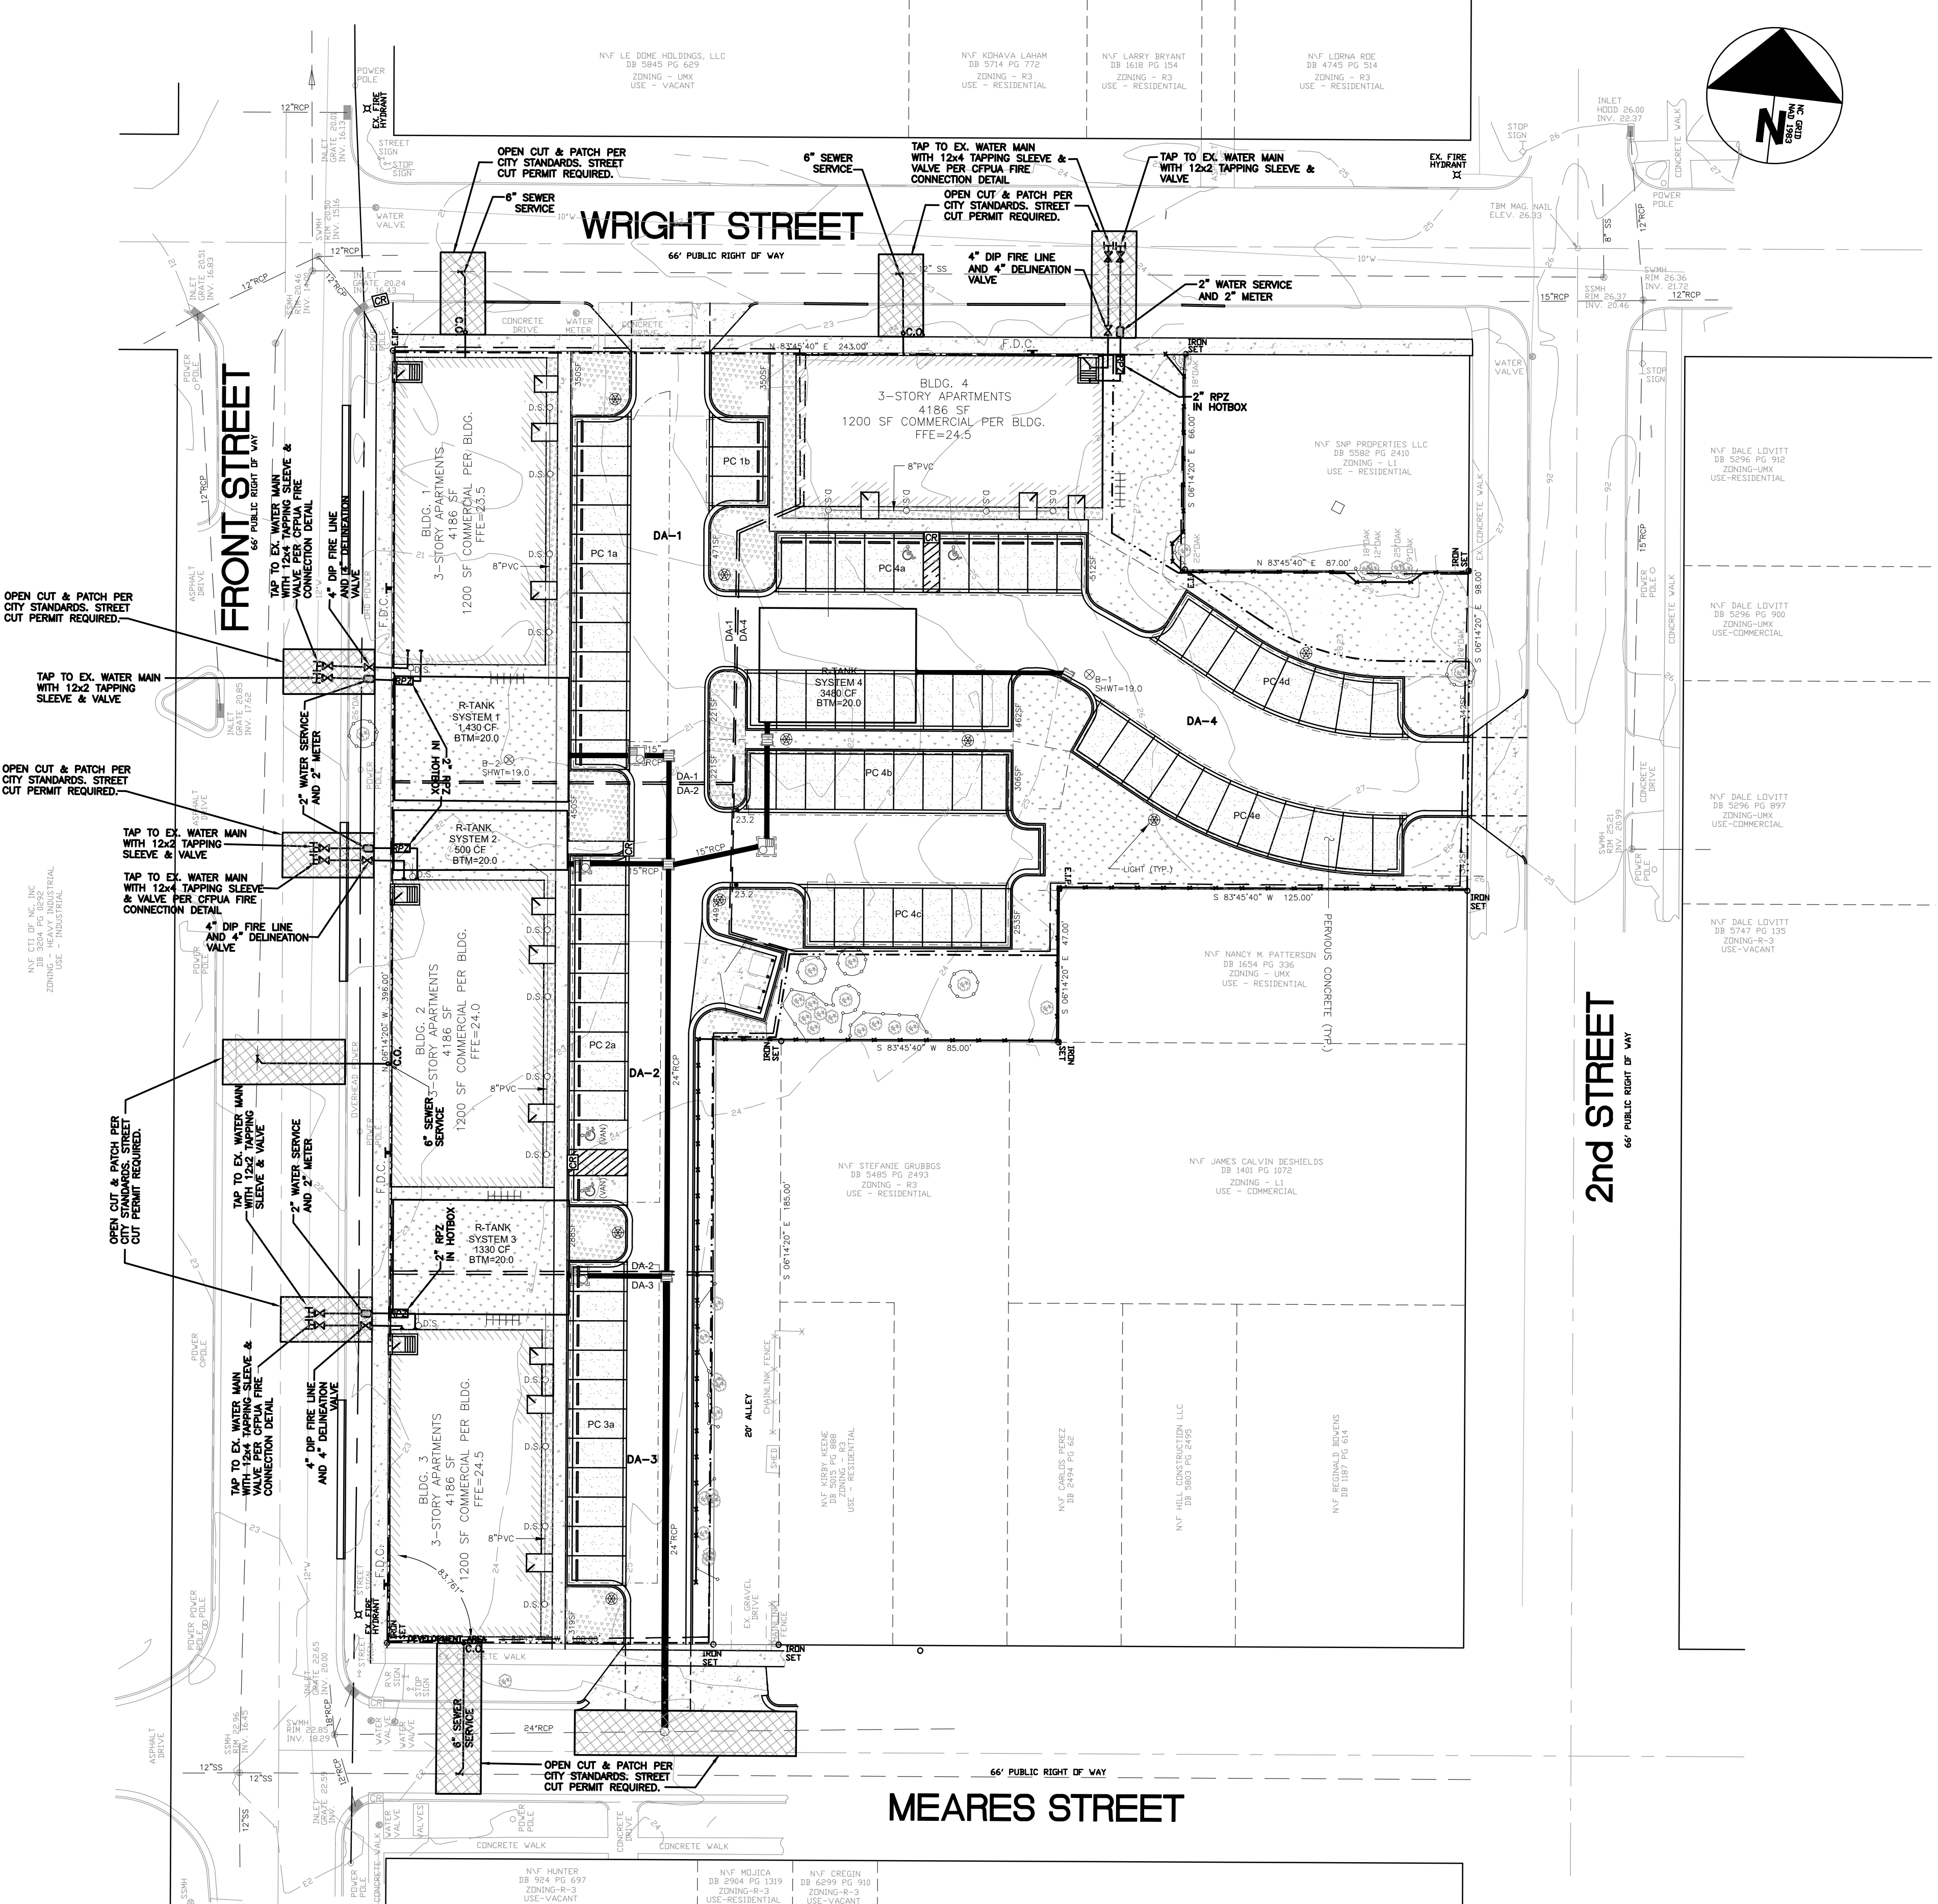

SITE DATA TABLE	
PIN	RS413-015-005-000
OWNER	DTSC, LLC
OWNER ADDRESS	401 CHESTNUT ST., SUITE A
SITE ADDRESS	102 WRIGHT ST.
	WILMINGTON, NC 28401
ZONING	URM - URBAN MIXED USE
CURRENT LAND USE	VACANT
ACREAGE	80,213 SF = 1.84 AC.
REQUIRED SETBACKS	0' - ALL SIDES
EXISTING BLDG.	10,500 SF
EX. GRAVEL DRIVE	10,500 SF
TOTAL EX. IMPERVIOUS	10,500 SF
EX. IMPERVIOUS TO BE REMOVED	10,500 SF
REMAINING EX. IMPERVIOUS	0 SF
PROPOSED UNITS	4 3-STORY UNITS
INFORMATION PER UNIT	
TOTAL BUILDING FOOTPRINT	4,186 SF
BUILDING HEIGHT	34'
COMMERCIAL SPACE	4,800 SF
2-BEDROOM UNITS	5
1-BEDROOM UNITS	3
STUDIO UNITS	8
TOTAL BEDS	21
TOTAL PROJECT BEDROOMS	84
SF PER FLOOR	4,186 SF
TOTAL BUILDING SF (FOOTPRINT)	16,744 SF
IMPERVIOUS PAVEMENT	14,900 SF
CONCRETE SIDEWALK	2,175 SF
CONCRETE CURB AND GUTTER	3,524 SF
TOTAL IMPERVIOUS	37,524 SF
PERVIOUS CONCRETE (PARKING)	13,850 SF
LOT COVERAGE/PERVIOUS BUILT-UPON AREA	37,524 SF = 86 AC = 63.9%
TOTAL PARKING SPACES PROVIDED	(4) 2 REGULAR / 2 VAN SPACES
ADA PARKING SPACES PROVIDED	1
BIKE PARKING REQUIRED/PROVIDED	1/20
DISTURBED AREA	85,620 SF = 1.97 AC.
BUILDING CONSTRUCTION TYPE	WOOD FRAMED, NC TYPE V-B
CANA LAND USE DESIGNATION	URBAN
ESTIMATED TRIP GENERATION	
RESIDENTIAL	422 TOTAL, 298AM PEAK, 370PM PEAK
COMMERCIAL - GENERAL OFFICE	28 TOTAL, 49AM PEAK, 48PM PEAK
COMMERCIAL - RETAIL	108 TOTAL, 168AM PEAK, 78PM PEAK
DEVELOPED AREA	70,485 SF = 1.6 AC.

- NOTES:
- THE CONSTRUCTION SITE IS NOT LOCATED IN A FEMA FLOOD HAZARDOUS ZONE.
  - FIRM # 3720311700K, JUNE 2, 2006
  - THERE ARE NO WETLANDS ON THE SITE.
  - PRIOR TO ANY CLEARING, GRADING OR CONSTRUCTION ACTIVITY, TREE PROTECTION FENCING SHALL BE INSTALLED AROUND PROTECTED TREES OR GROVES OF TREES. NO CONSTRUCTION WORKERS, TOOLS, MATERIALS, OR VEHICLES ARE PERMITTED WITHIN THE TREE PROTECTION FENCING.
  - ANY TREES AND/OR AREAS DESIGNATED TO BE PROTECTED MUST BE PROPERLY BARRICADED WITH FENCING AND PROTECTED THROUGHOUT CONSTRUCTION TO INSURE THAT NO CLEARING, GRADING OR OR ARCHEOLOGICAL RESOURCES ON THIS SITE.
  - NO EQUIPMENT IS ALLOWED ON SITE UNTIL ALL TREE PROTECTION FENCING AND SILT FENCING IS INSTALLED AND APPROVED. PROTECTIVE FENCING IS TO BE MAINTAINED THROUGHOUT THE DURATION OF THE PROJECT, AND CONTRACTORS SHALL RECEIVE ADEQUATE INSTRUCTION ON TREE PROTECTION METHODS.
  - TRAFFIC CONTROL DEVICES (INCLUDING SIGNS AND PAVEMENT MARKINGS) IN AREAS OPEN TO PUBLIC TRAFFIC ARE TO MEET MUTCD (MANUAL ON UNIFORM TRAFFIC CONTROL DEVICES) STANDARDS.
  - IF THE CONTRACTOR DESIRES WATER FOR CONSTRUCTION, HE SHALL APPLY IN ADVANCE FOR THIS SERVICE FROM CAPE FEAR PUBLIC UTILITY AUTHORITY (CFPUA) AND MUST PROVIDE A REDUCED PRESSURE ZONE (RPZ) BACKFLOW PREVENTION DEVICE ON THE DEVELOPER'S SIDE OF THE METER BOX. ANY BACKFLOW PREVENTION DEVICES REQUIRED WILL NEED TO BE ON THE LIST OF DEVICES APPROVED BY USCFCCOHR OR ASSE.
  - ANY IRRIGATION SYSTEM SUPPLY BY CFPUA WATER SHALL COMPLY WITH THE CFPUA CROSS CONNECTION CONTROL REGULATIONS.
  - CONTACT THE NORTH CAROLINA ONE CALL CENTER AT 1-800-632-4949 PRIOR TO DOING ANY DIGGING, CLEARING OR GRADING.
  - THE BELLSOUTH CONTACT IS STEVE DAYVAULT. HE IS THE BUILDING INDUSTRY CONSULTANT (910) 392-8712. PLEASE CONTACT HIM PRIOR TO STARTING THE PROJECT IN ORDER TO FACILITATE GOOD COMMUNICATION AND MAXIMUM FLEXIBILITY.
  - ALL PLANTED AND RETAINED LIVING MATERIAL REQUIRED TO MEET THE PROVISIONS OF THE CITY OF WILMINGTON LAND DEVELOPMENT CODE, SHALL BE PERPETUALLY PROTECTED AND MAINTAINED TO PROFESSIONAL ACCEPTED STANDARDS BY JOINT AND SEVERAL RESPONSIBILITY OF THE OWNER, TENANT AND RESPECTIVE AGENTS OF THE PROPERTY ON WHICH THE MATERIAL IS LOCATED.
  - ANY PLANT MATERIAL THAT WAS PREVIOUSLY INSTALLED ON THE SITE TO MEET THE PROVISIONS OF THE CITY OF WILMINGTON LAND DEVELOPMENT CODE THAT HAS NOT BEEN MAINTAINED MUST BE REPLACED.
  - AS PART OF THE FINAL ZONING INSPECTION FOR THIS PROJECT, A SURVEY OF THE SITE LANDSCAPING WILL BE CONDUCTED. PLANT MATERIAL THAT HAS NOT BEEN MAINTAINED MUST BE REPLACED BEFORE A FINAL ZONING APPROVAL IS ISSUED.
  - ALL PARKING STALL MARKINGS AND LANE ARROWS WITHIN THE PARKING AREAS SHALL BE WHITE.
  - ALL TRAFFIC CONTROL SIGNS AND MARKINGS OFF THE RIGHT-OF-WAY ARE TO BE MAINTAINED BY THE PROPERTY OWNER IN ACCORDANCE WITH MUTCD STANDARDS.
  - A RAIN/FREEZE SENSOR SHALL BE INSTALLED AS PART OF ANY IRRIGATION SYSTEM USED ON THE SITE.
  - CONTACT TRAFFIC ENGINEERING AT 910-341-7888 48 HOURS PRIOR TO ANY EXCAVATION IN THE RIGHT-OF-WAY TO ENSURE THAT ALL TRAFFIC SIGNAL FACILITIES AND EQUIPMENT ARE PROPERLY LOCATED.
  - A UTILITY CUT PERMIT IS REQUIRED FOR EACH OPEN CUT OF A CITY STREET. NOTE THIS ON THE PLAN AND CONTACT 341-5888 FOR MORE DETAILS. IN CERTAIN CASES AN ENTIRE RESURFACING OF THE AREA BEING OPEN CUT MAY BE REQUIRED.
  - TACTILE WARNING MATS WILL BE INSTALLED ON ALL WHEELCHAIR RAMPS.
  - CONTACT TRAFFIC ENGINEERING AT 910-341-7888 TO DISCUSS STREET LIGHTING OPTIONS.
  - ANY BACKFLOW PREVENTION DEVICES REQUIRED BY THE CFPUA WILL NEED TO BE ON THE LIST OF APPROVED DEVICES BY USCFCCOHR OR ASSE.
  - CONTRACTOR TO FIELD VERIFY EXISTING WATER AND SEWER SERVICE LOCATIONS, SIZES AND MATERIALS PRIOR TO CONSTRUCTION. ENGINEER TO BE NOTIFIED OF ANY CONFLICTS.
  - CONTRACTOR SHALL MAINTAIN ALL-WEATHER ACCESS FOR EMERGENCY VEHICLES AT ALL TIMES DURING CONSTRUCTION.
  - ALL PAVEMENT MARKINGS IN PUBLIC RIGHTS-OF-WAY AND FOR DRIVEWAYS ARE TO BE THERMOPLASTIC AND MEET CITY AND/OR NCDOT STANDARDS.
  - TRAFFIC ENGINEERING MUST APPROVE OF PAVEMENT MARKING PRIOR TO ACTUAL STRIPING.
  - ANY BROKEN OR MISSING SIDEWALK PANELS, DRIVEWAY PANELS AND CURBING WILL BE REPLACED.
  - PROJECT SHALL COMPLY WITH CFPUA CROSS CONNECTION CONTROL REQUIREMENTS. WATER METER(S) CANNOT BE RELEASED UNTIL ALL REQUIREMENTS ARE MET AND THE STATE HAS GIVEN THEIR FINAL APPROVAL. CALL 910-343-3911 FOR INFORMATION.
  - PARKING SPACES NOT REQUIRED FOR STORAGE FACILITIES. SIX ARE PROVIDED WITH TWO BEING ADA.
  - ALL NEW UTILITIES SHALL BE INSTALLED UNDERGROUND, EXCEPT WHERE SUCH PLACEMENT IS PROHIBITED OR DEEMED IMPRACTICAL BY THE UTILITY PROVIDER. UNDERGROUND TERMINAL FACILITIES FOR STREET LIGHTING ALONG ALL PUBLIC STREETS ABUTTING THE SUBJECT SITE SHALL BE INSTALLED BY THE DEVELOPER.
  - IMMEDIATELY NOTIFY CITY OF WILMINGTON TRAFFIC ENGINEERING AT 910-341-7888 IF ANY TRAFFIC SIGNAL FACILITIES OR CITY-OWNED STREETLIGHT FACILITIES ARE DAMAGED.
  - DAMAGED FACILITIES SHALL BE REPLACED BY AN APPROVED CONTRACTOR, ACCORDING TO STANDARD NCDOT REPLACEMENT SCHEDULES AND CURRENT NCDOT DESIGN STANDARDS.
  - ALL REPAIR/REPLACEMENT OF TRAFFIC SIGNAL INFRASTRUCTURE SHALL BE COORDINATED WITH THE CITY OF WILMINGTON TRAFFIC ENGINEERING DIVISION.
  - WATER AND SEWER SERVICES ARE NOT REQUIRED FOR THIS DEVELOPMENT.
  - UNDERGROUND FIRE LINE(S) MUST BE PERMITTED AND INSPECTED BY THE WILMINGTON FIRE DEPT. FROM PUBLIC RIGHT-OF-WAY TO THE BUILDING. CONTACT WILMINGTON FIRE DEPT. DIVISION OF FIRE AND LIFE SAFETY AT 910-341-0696.
  - NO OBSTRUCTIONS ARE PERMITTED IN THE SPACE BETWEEN THIRTY (30) INCHES AND TEN (10) FEET ABOVE THE GROUND WITHIN THE TRIANGULAR SIGHT DISTANCE.
  - EXISTING WATER AND SEWER BY CFPUA.
  - EXISTING STORMWATER SYSTEM BY CITY OF WILMINGTON.
  - SOLID WASTE DISPOSAL WILL NOT BE PROVIDED TO UNITS.

LINE LEGEND	
	PROPERTY LINE
	ADJACENT PROPERTY LINE
	PRIVACY FENCE
	PERVIOUS CONCRETE DRAINAGE AREA
	DRAINAGE AREA

**CITY OF WILMINGTON**  
NORTH CAROLINA  
Public Services • Engineering Division  
APPROVED STORMWATER MANAGEMENT PLAN  
Date: \_\_\_\_\_ Permit # \_\_\_\_\_  
Signed: \_\_\_\_\_

**Approved Construction Plan**  
Name: \_\_\_\_\_ Date: \_\_\_\_\_  
Planning  
Traffic  
Fire



FOR REGULATORY REVIEW - NOT FOR CONSTRUCTION

REV. NO.	DESCRIPTION	DATE

**102 WRIGHT STREET - OWNER: DTSC LLC**  
**THE BLOCK ON FRONT**  
WILMINGTON NORTH CAROLINA

**UTILITY PLAN**

**RIGHT ANGLE ENGINEERING, P.C.**  
212 PRINCESS STREET  
WILMINGTON, NC 28401  
(910) 251-8544 FAX (910) 251-2208 FIRM: C-0829

DATE: 8/8/22  
Scale: 1"=30'  
Drawn: NNC  
Checked: WSL  
Project No: HA0121  
Sheet No: **C4**
















TOP BACKFILL: 18" MIN. STRUCTURAL FILL (24" RECOMMENDED, SIMILAR TO SIDE BACKFILL). MATERIAL ABOVE THE GEOGRID MAY VARY BASED ON INTENDED USE, BUT IN NO CASE SHOULD THE CLAY CONTENT EXCEED 10%. A MIN. 12" COVER MUST BE MAINTAINED BETWEEN BACKFILL EQUIPMENT AND THE TOP OF THE R-TANK™ SYSTEM AT ALL TIMES. FOR BEST RESULTS, PUSH OUT 14" TO MAINTAIN A MIN. 12" COVER REFER TO THE R-TANK™ INSTALLATION GUIDE FOR LISTING OF ACCEPTABLE EQUIPMENT. TOTAL HEIGHT OF TOP BACKFILL SHOULD NOT EXCEED 7' CONTACT ACF ENVIRONMENTAL IF MORE THAN 7' OR LESS THAN 24" OF TOP BACKFILL IS REQUIRED (FROM TOP OF TANK TO TOP OF PAVEMENT).

**NOTES:**

- FOR COMPLETE MODULE DATA, SEE APPROPRIATE R-TANK™ "SD" SHEET (SINGLE MODULE, DOUBLE MODULE, TRIPLE MODULE, QUAD MODEL, OR PENTA MODEL)
- INSTALLATIONS PER THIS DETAIL MEET GUIDELINES OF H20 LOADING PER THE 1983, 13TH EDITION OF THE AMERICAN ASSOCIATION OF STATE, HIGHWAY AND TRAFFIC OFFICIALS (AASHTO) STANDARD SPECIFICATIONS
- PRE-TREATMENT STRUCTURES NOT SHOWN
- GEOGRID (TENSAR BX-1200 OR EQUAL) PLACED 12" ABOVE THE R-TANK™ SYSTEM. OVERLAP ADJACENT PANELS BY 18" MIN. GEOGRID SHOULD EXTEND 3' BEYOND THE EXCAVATION FOOTPRINT.

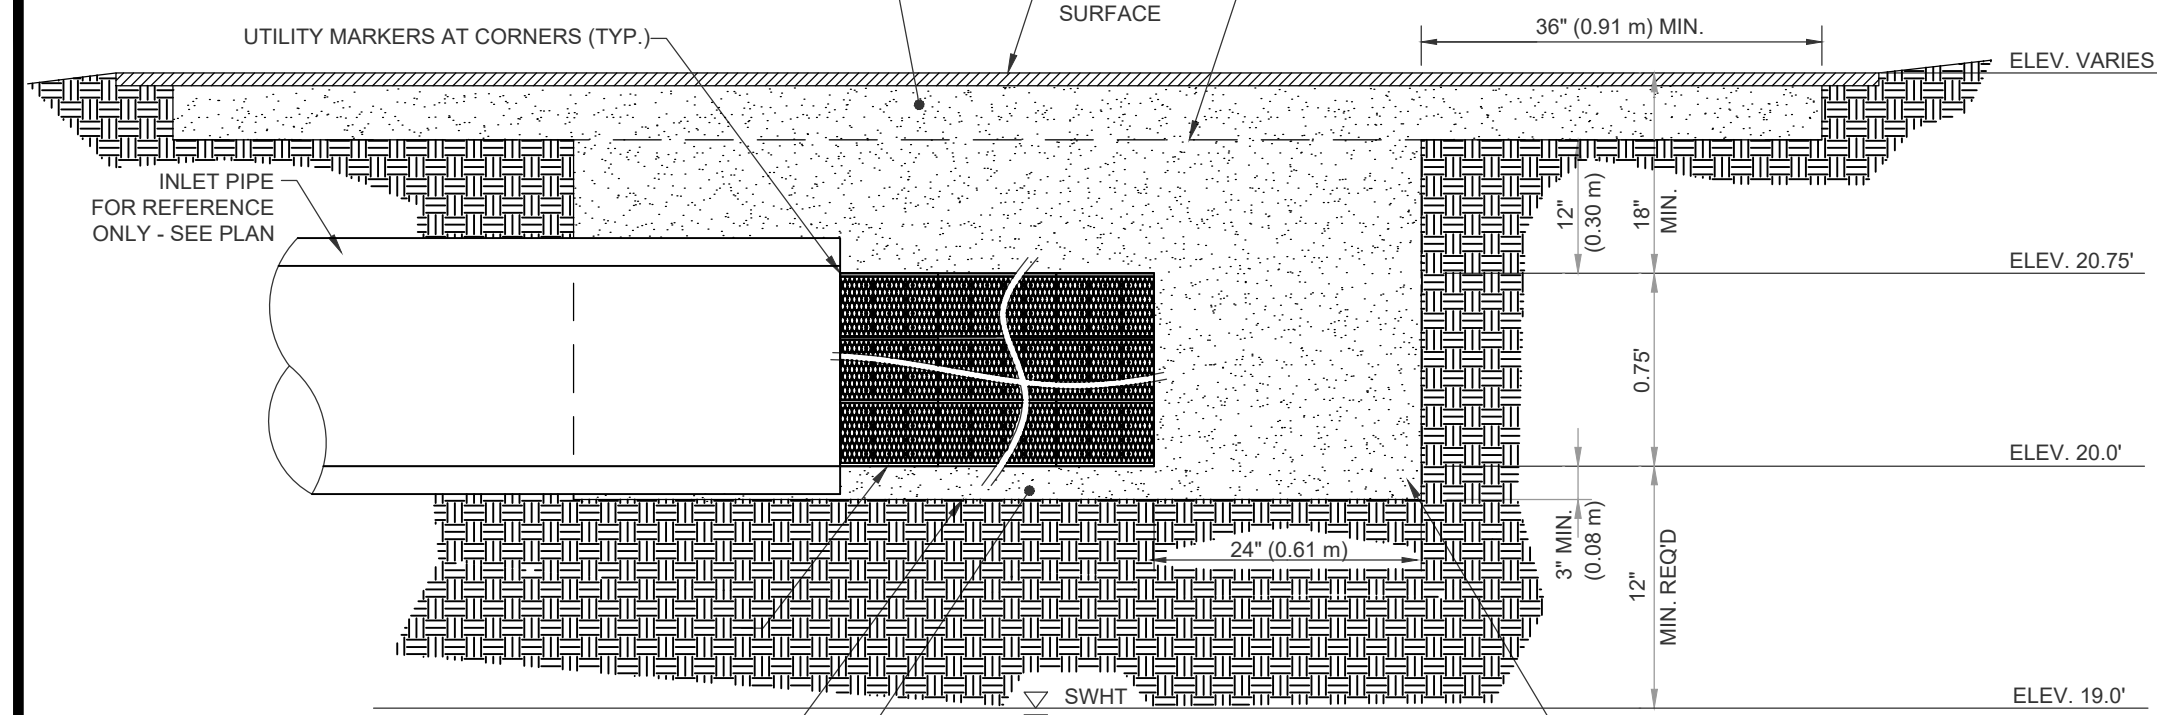


**INFILTRATION GALLERY H2O LOADS**  
NOT TO SCALE

BASE: 3" MIN. SUITABLE STRUCTURAL BACKFILL COMPACTED TO 95% STANDARD PROCTOR DENSITY IS REQUIRED TO PROVIDE A LEVEL BASE SURFACE. MUST BE SMOOTH, FREE OF LUMPS OR DEBRIS, AND EXTEND 2' BEYOND R-TANK™ FOOTPRINT. A CBR GREATER THAN 5 MUST BE ACHIEVED PRIOR TO INSTALLING ANY R-TANK™. SAND MAY BE ACCEPTABLE, BUT IN NO CASE SHALL CLAY BE USED.


R-TANK™ UNITS WRAPPED IN WOVEN MONOFILAMENT POLYPROPYLENE GEOTEXTILE (ACF M200 OR PRIOR APPROVED EQUIVALENT) LOAD RATING: 32 PSI (MODULE ONLY) EXCAVATION LINE

TRASHGUARD DETAILS				
SIZES	23"	28"	34"	
A PIPE DIAMETER	≤ 15	≤ 18	≤ 24	
B HEIGHT	24"	30"	36"	
C WIDTH	23"	28"	34"	

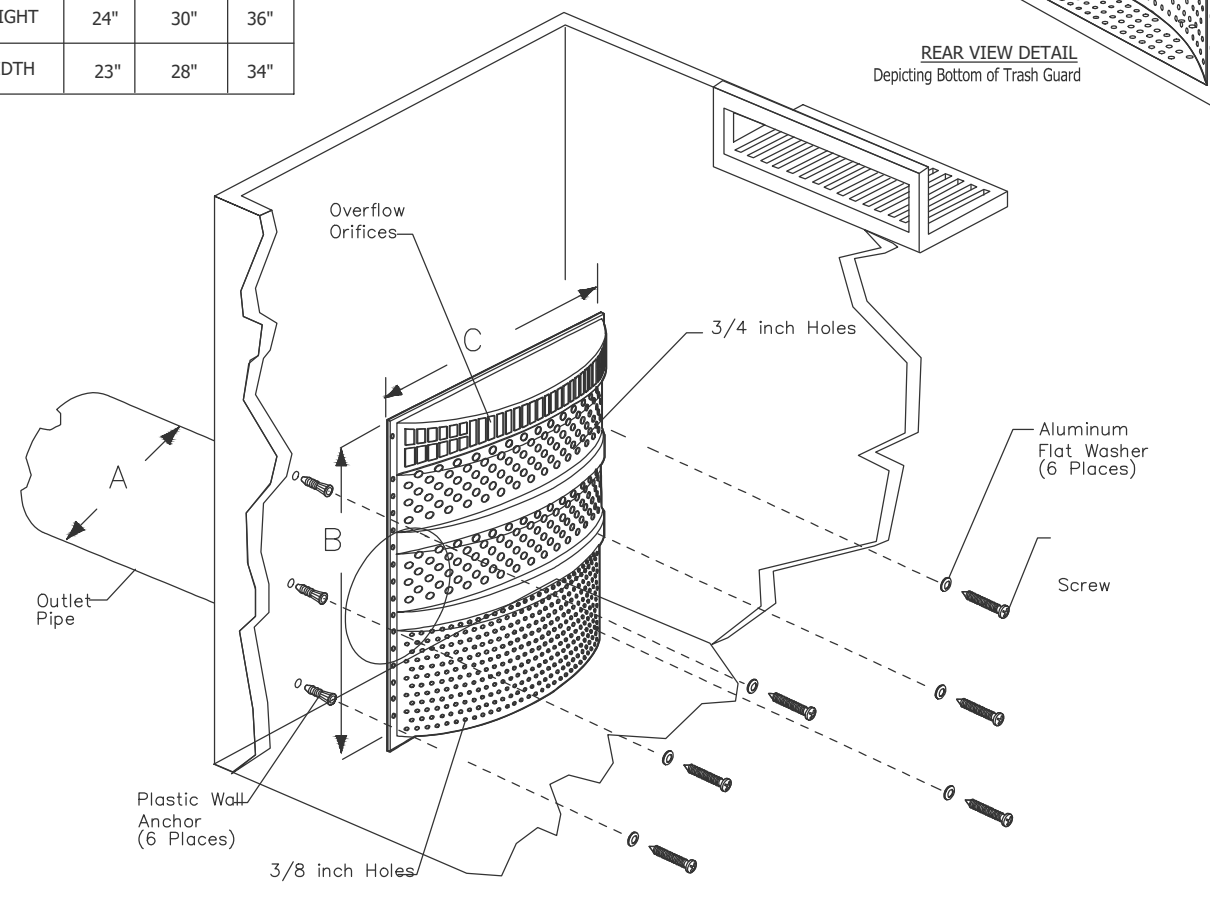


**TRASH GUARD IN INLET STRUCTURE**  
NOT TO SCALE

SYSTEM	STORAGE VOLUME	LENGTH	WIDTH	BOTTOM ELEV.	O.S. SPILLWAY ELEV.	MODULE HEIGHT
DA-1	1430 CF	53.3	38	20.0	21.0	1 (9.5")
DA-2	911 CF	53.3	18.3	20.0	21.0	1 (9.5")
DA-3	1423 CF	54	35	20.0	21.0	1 (9.5")
DA-4	2400 CF	48	35	20.0	21.5	2 (19")

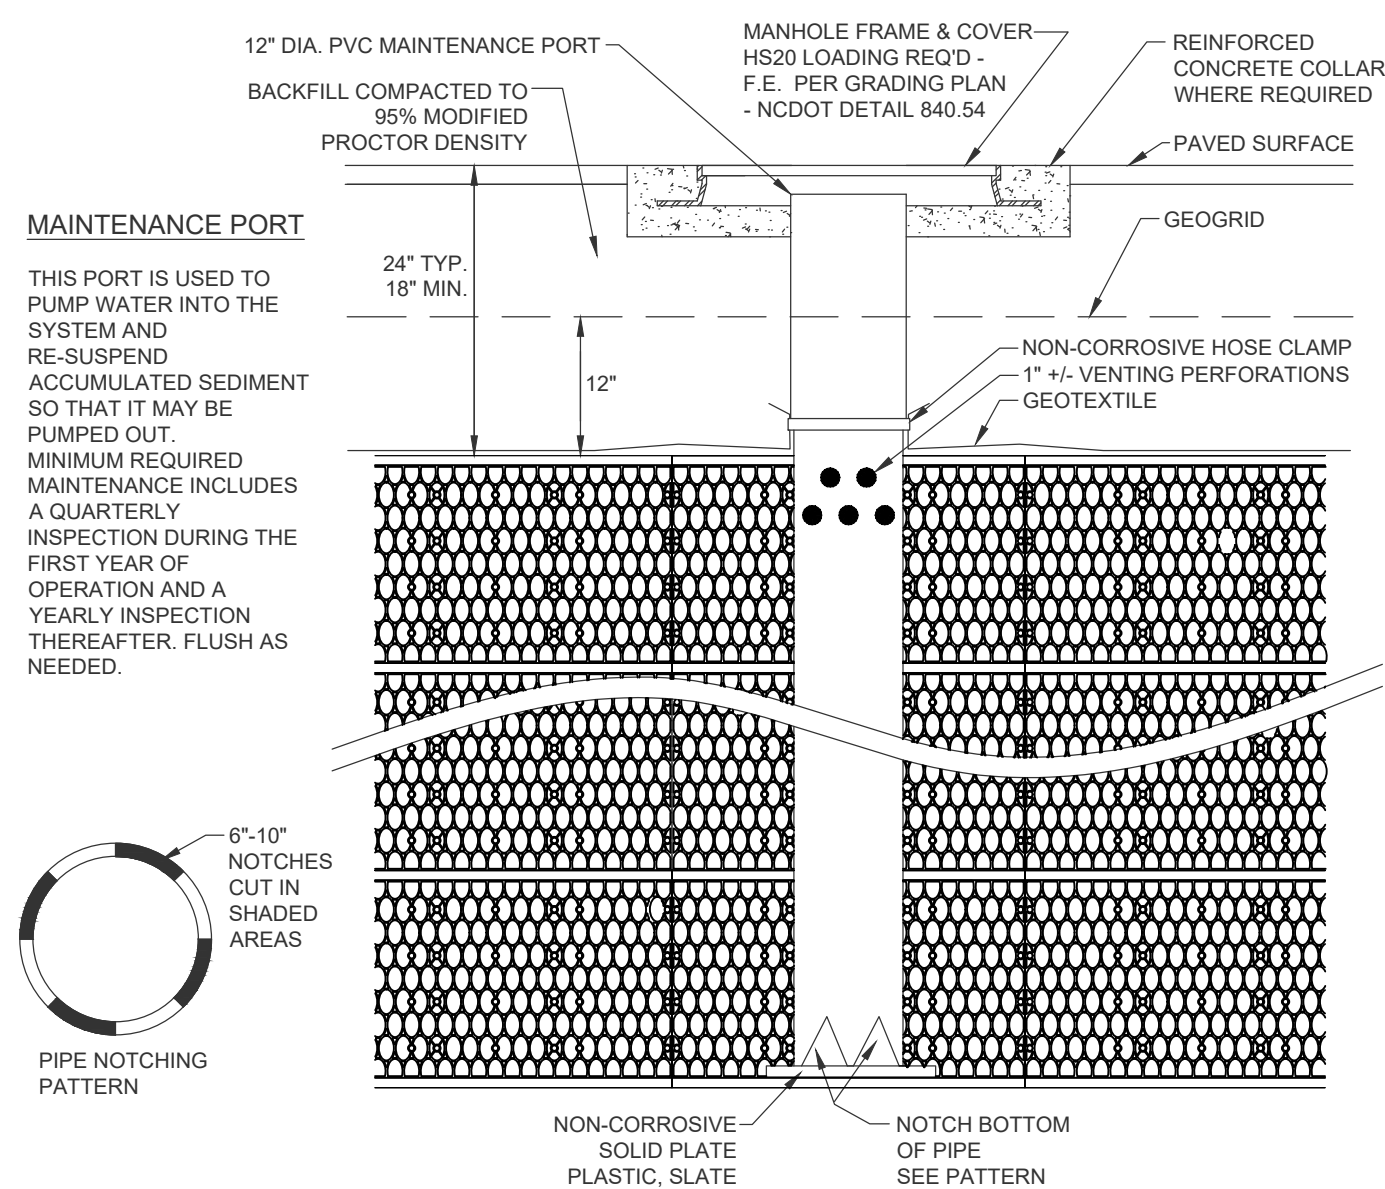

**INFILTRATION GALLERY - MAINTENANCE PORT**  
NOT TO SCALE

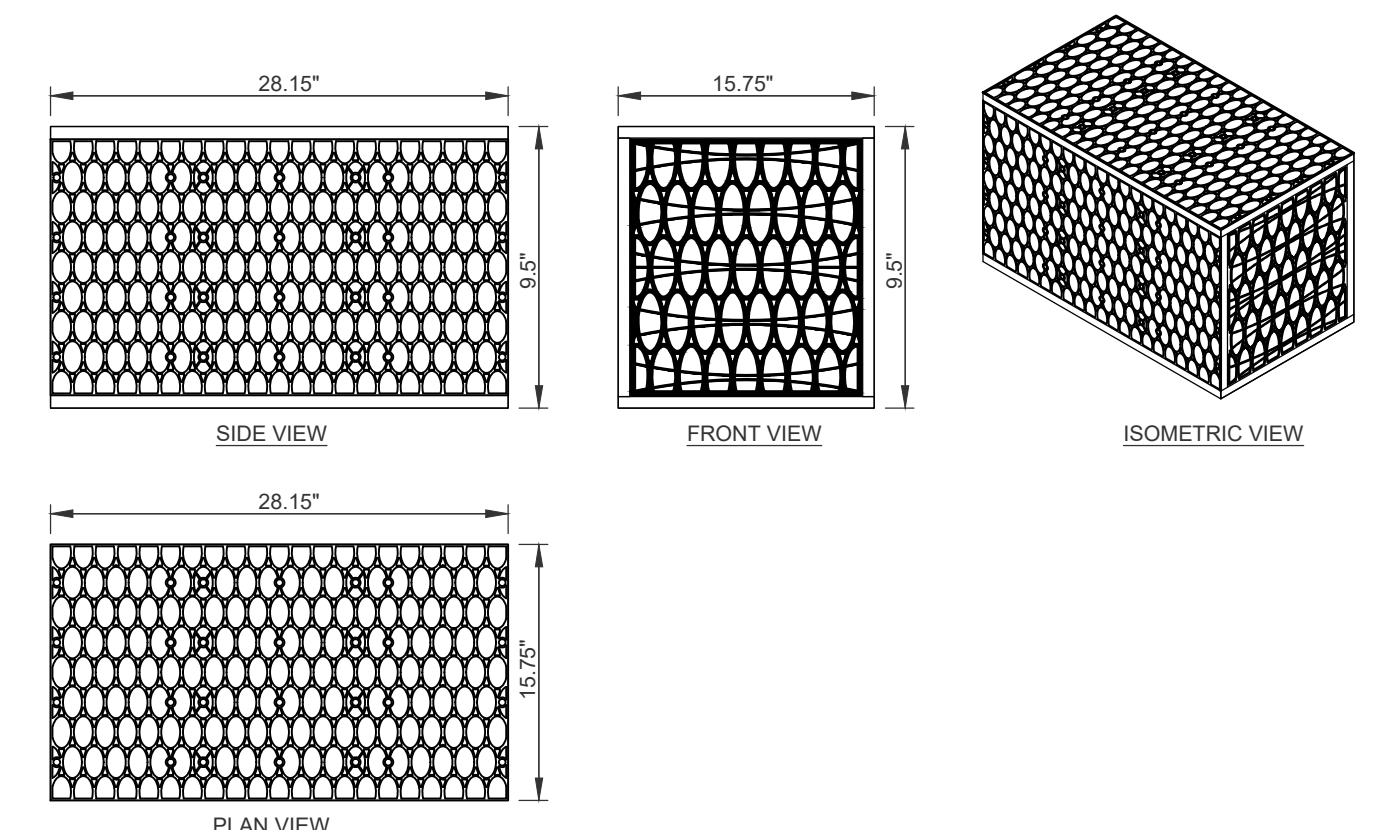


**MODULE DATA - R-TANK S.D.**


<b>GEOMETRY:</b> LENGTH = 28.15 IN. (715 MM)	<b>LOAD RATING:</b> 40 PSI, (MODULE ONLY) HS25, (WITH ACF COVER SYSTEM)
WIDTH = 15.75 IN. (400 MM)	
HEIGHT = 8.9" IN. (241.3 MM)	<b>MATERIAL:</b> 85% RECYCLED POLYPROPYLENE
STORAGE VOLUME = 2.42 CF (68.5 L)	
VOID INTERNAL VOLUME: 95%	
VOID SURFACE AREA: 90%	

NOTE: INFILTRATION GALLERY SHALL BE R-TANK HD SINGLE MODULE OR PRIOR APPROVED EQUIVALENT.


**INFILTRATION GALLERY - SINGLE MODULE**  
NOT TO SCALE

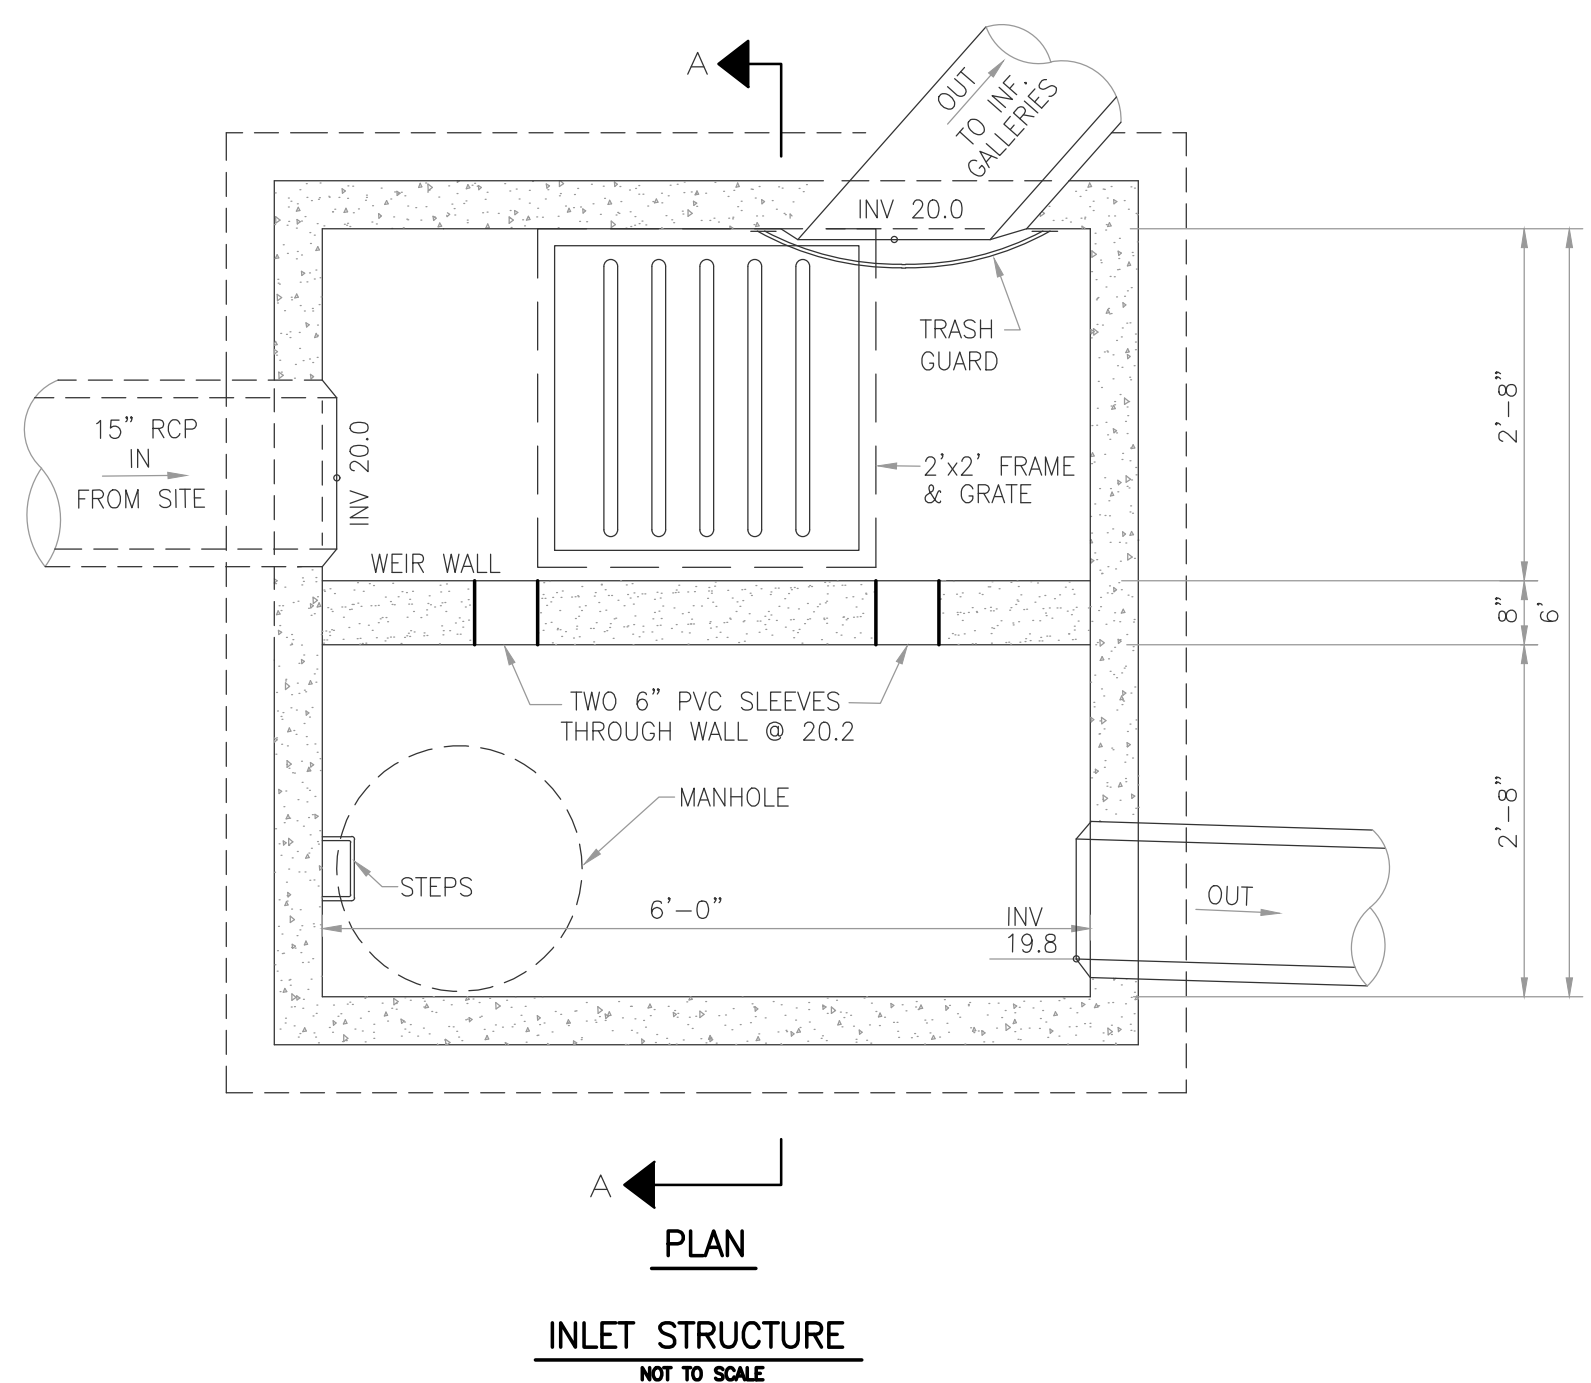


**INLET STRUCTURE**  
NOT TO SCALE

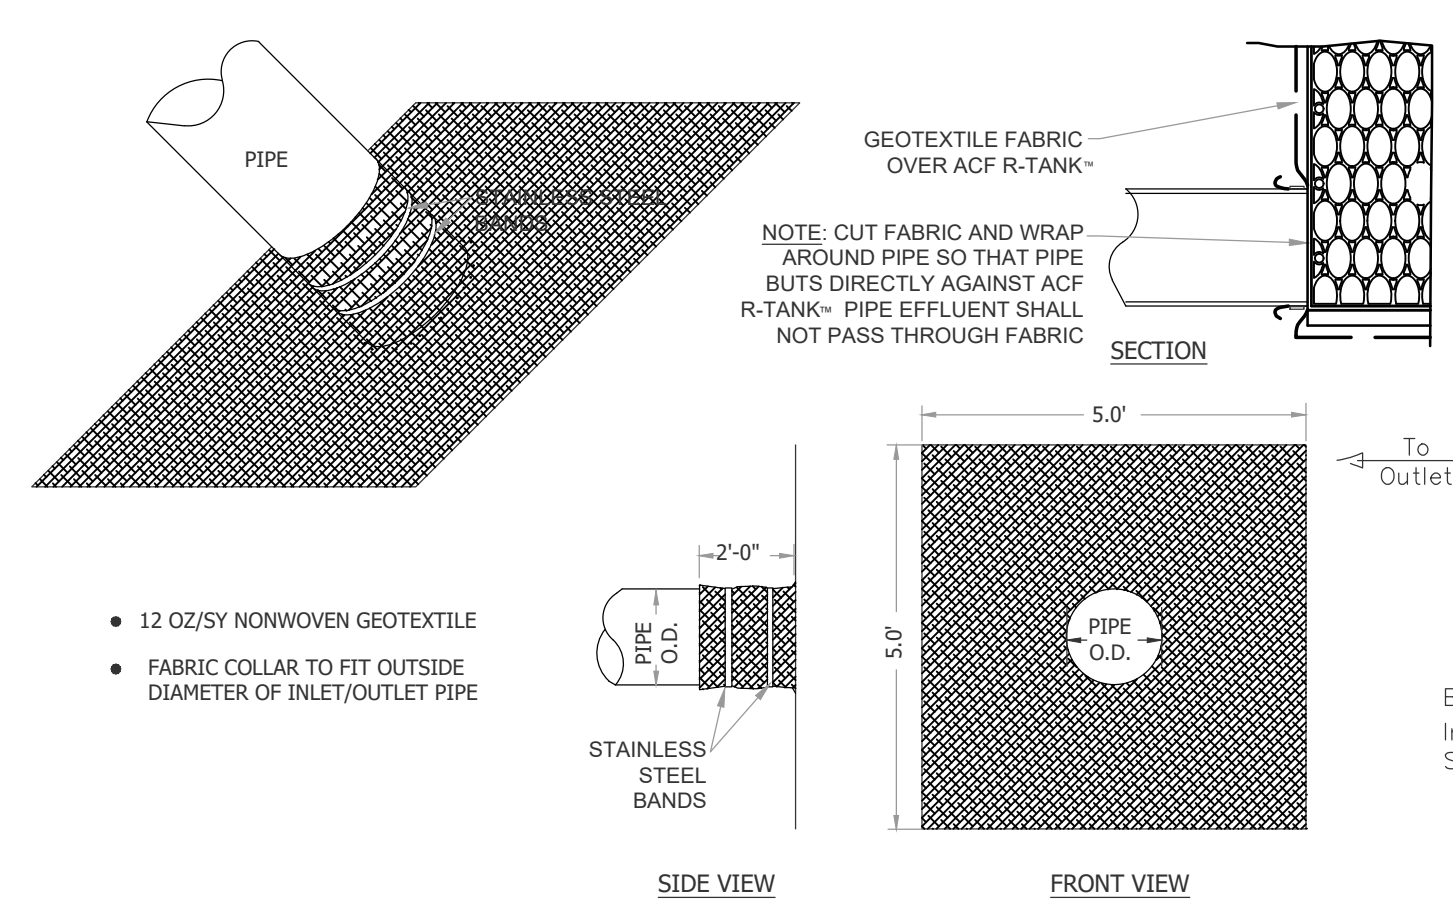

**INFILTRATION GALLERY - FABRIC PIPE BOOT**  
NOT TO SCALE

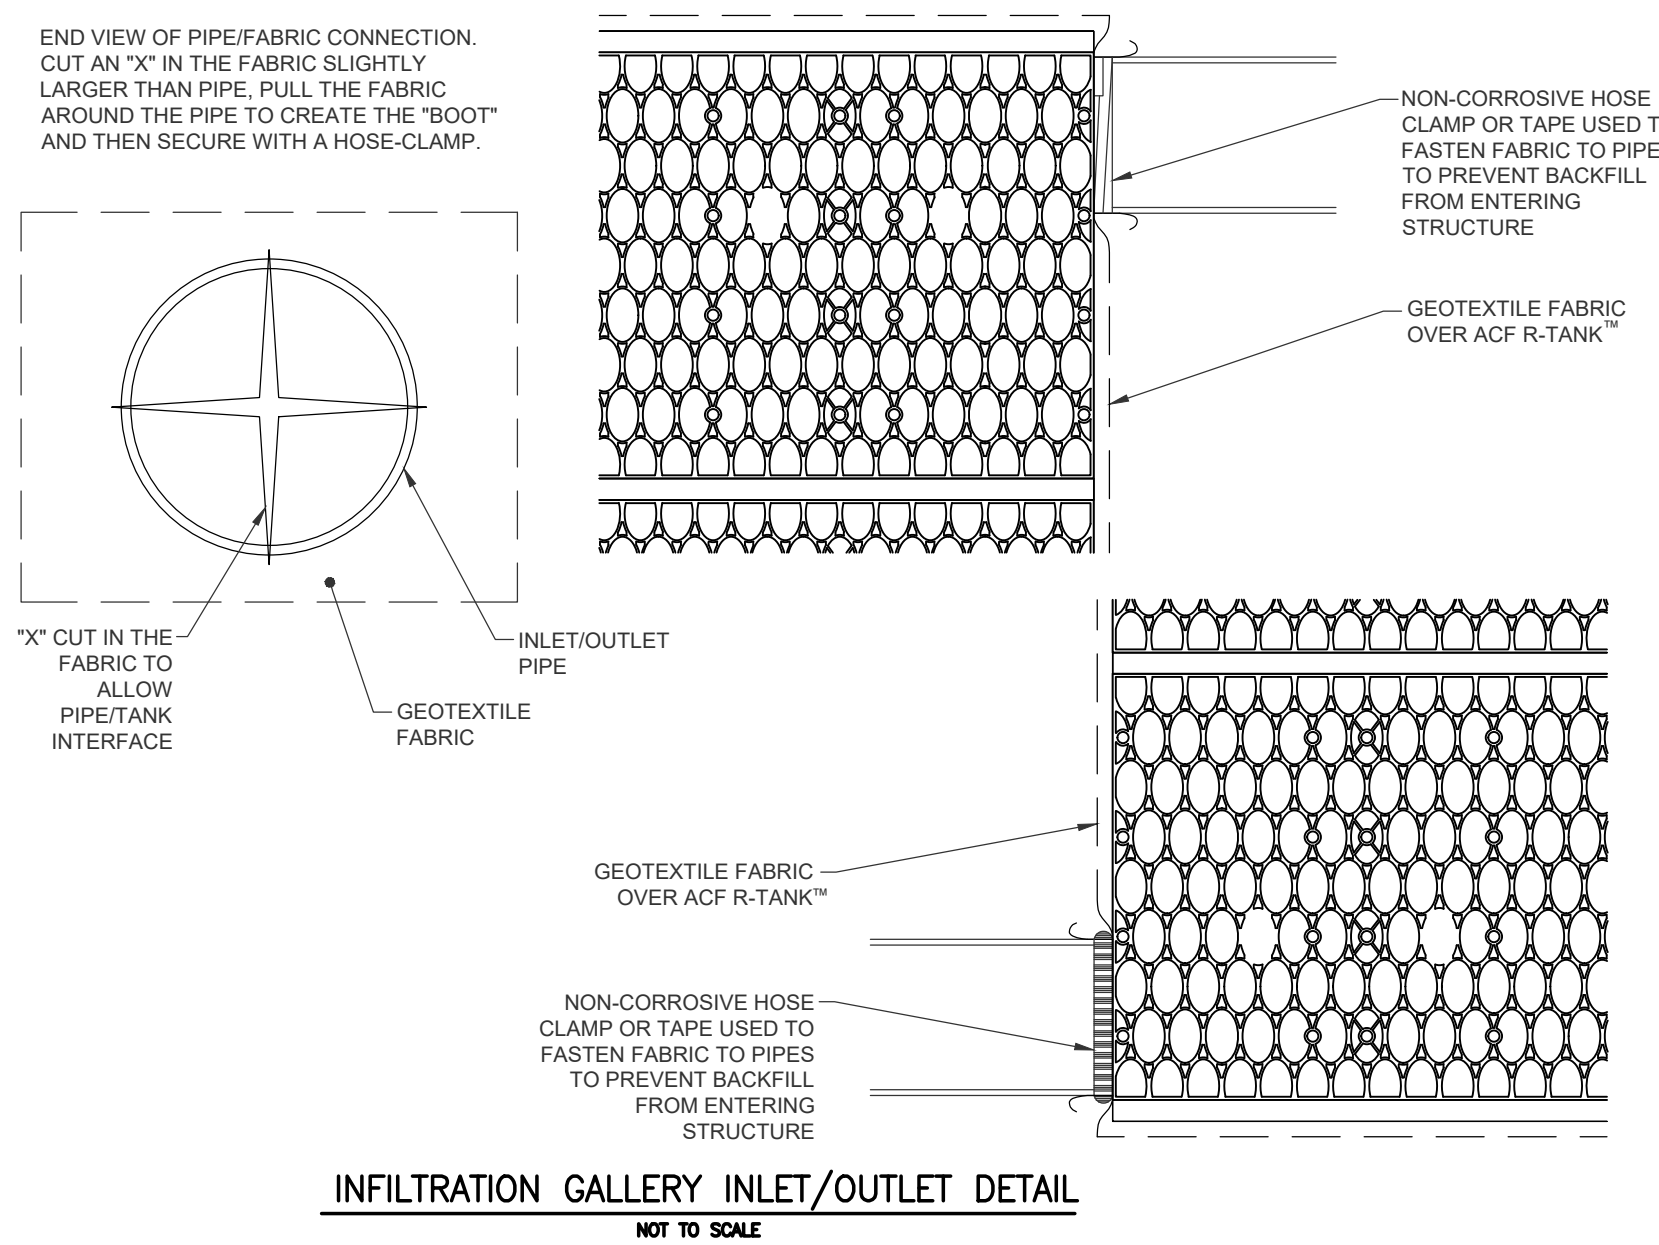


**INFILTRATION GALLERY INLET/OUTLET DETAIL**  
NOT TO SCALE

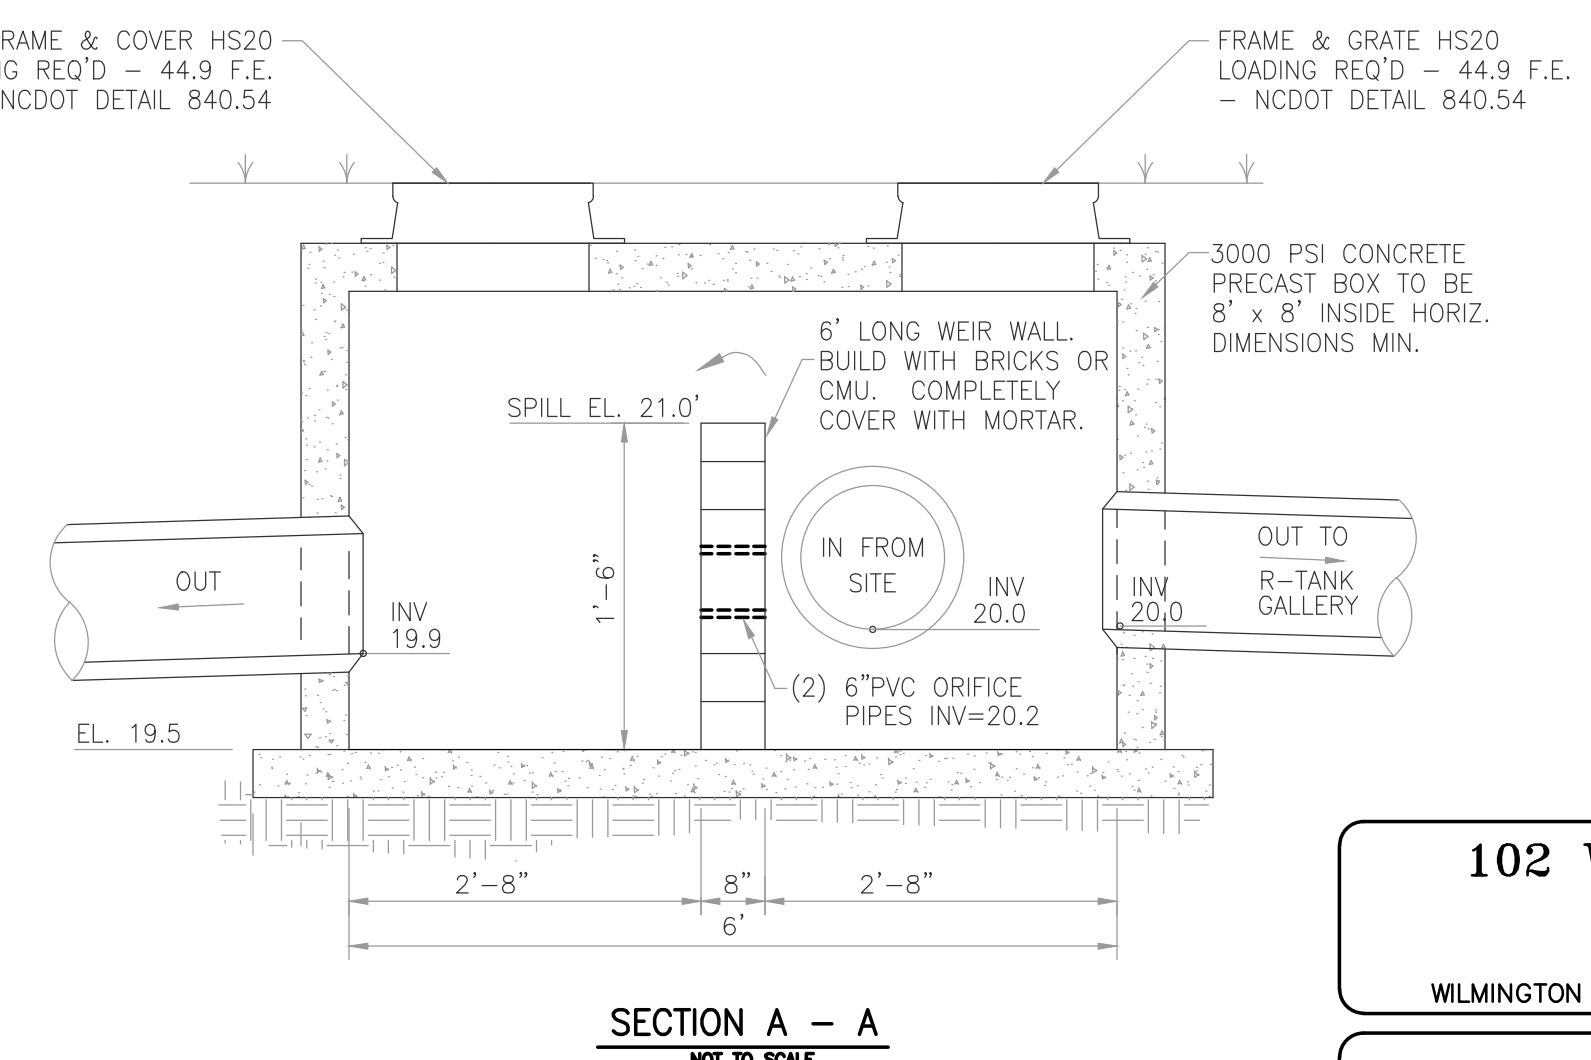


**SECTION A - A**  
NOT TO SCALE

FOR REGULATORY REVIEW - NOT FOR CONSTRUCTION

REV. NO.	DESCRIPTION	DATE

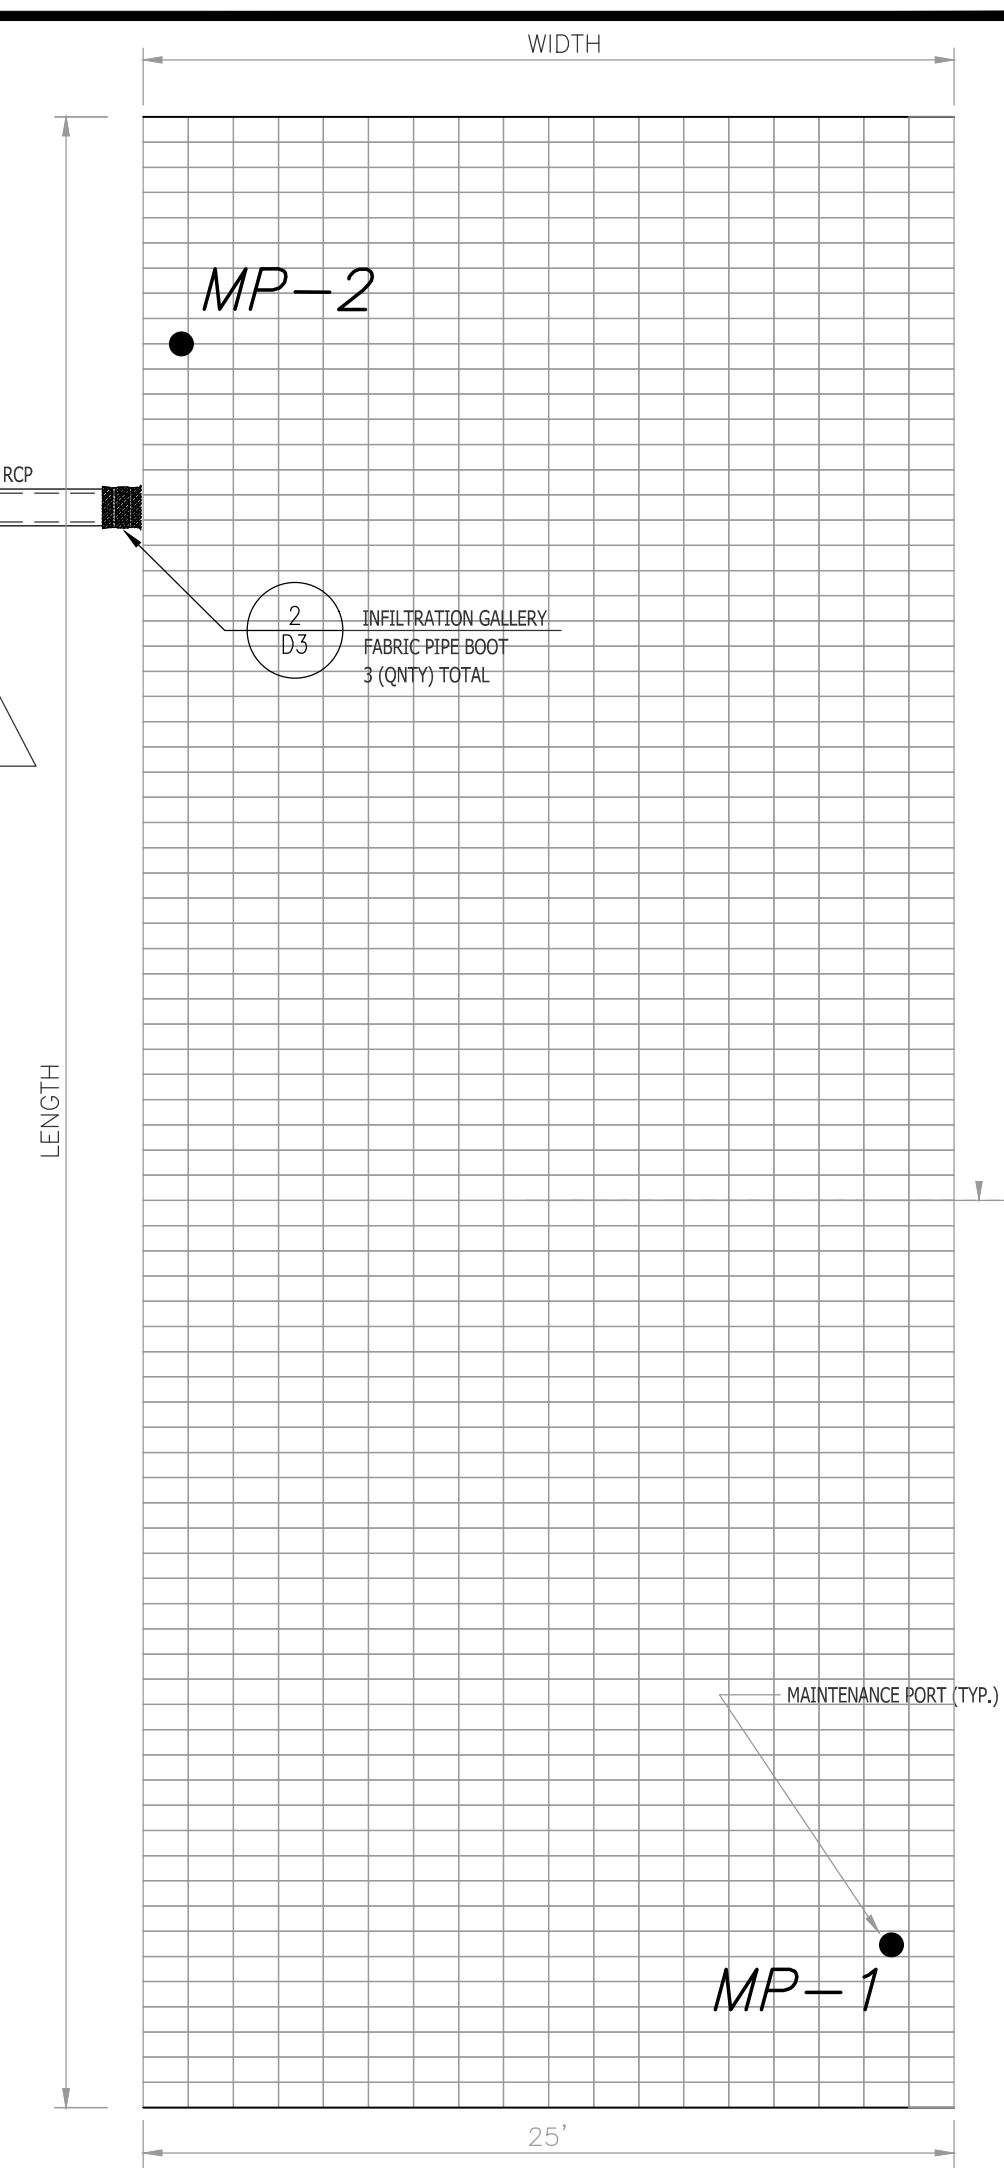

**INFILTRATION GALLERY LAYOUT**  
NOT TO SCALE

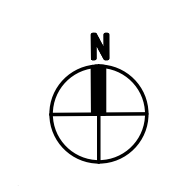

**CITY OF WILMINGTON**  
NORTH CAROLINA  
Public Services • Engineering Division  
APPROVED STORMWATER MANAGEMENT PLAN  
Date: \_\_\_\_\_ Permit # \_\_\_\_\_  
Signed: \_\_\_\_\_

**Approved Construction Plan**  
Name \_\_\_\_\_ Date \_\_\_\_\_  
Planning \_\_\_\_\_  
Traffic \_\_\_\_\_  
Fire \_\_\_\_\_

**102 WRIGHT STREET - OWNER: DTSC LLC**  
**THE BLOCK ON FRONT**  
WILMINGTON NEW HANOVER NORTH CAROLINA  
**SITE DETAILS**  
**RIGHT ANGLE ENGINEERING, P.C.**  
212 PRINCESS STREET WILMINGTON, NC 28401 (910) 251-8544 FAX (910) 251-2208 FIRM: C-0829  
DATE: 8/8/22  
Scale: SHOWN  
Drawn: NNC  
Checked: WSL  
Project No: HA0121  
Sheet No: **D4**














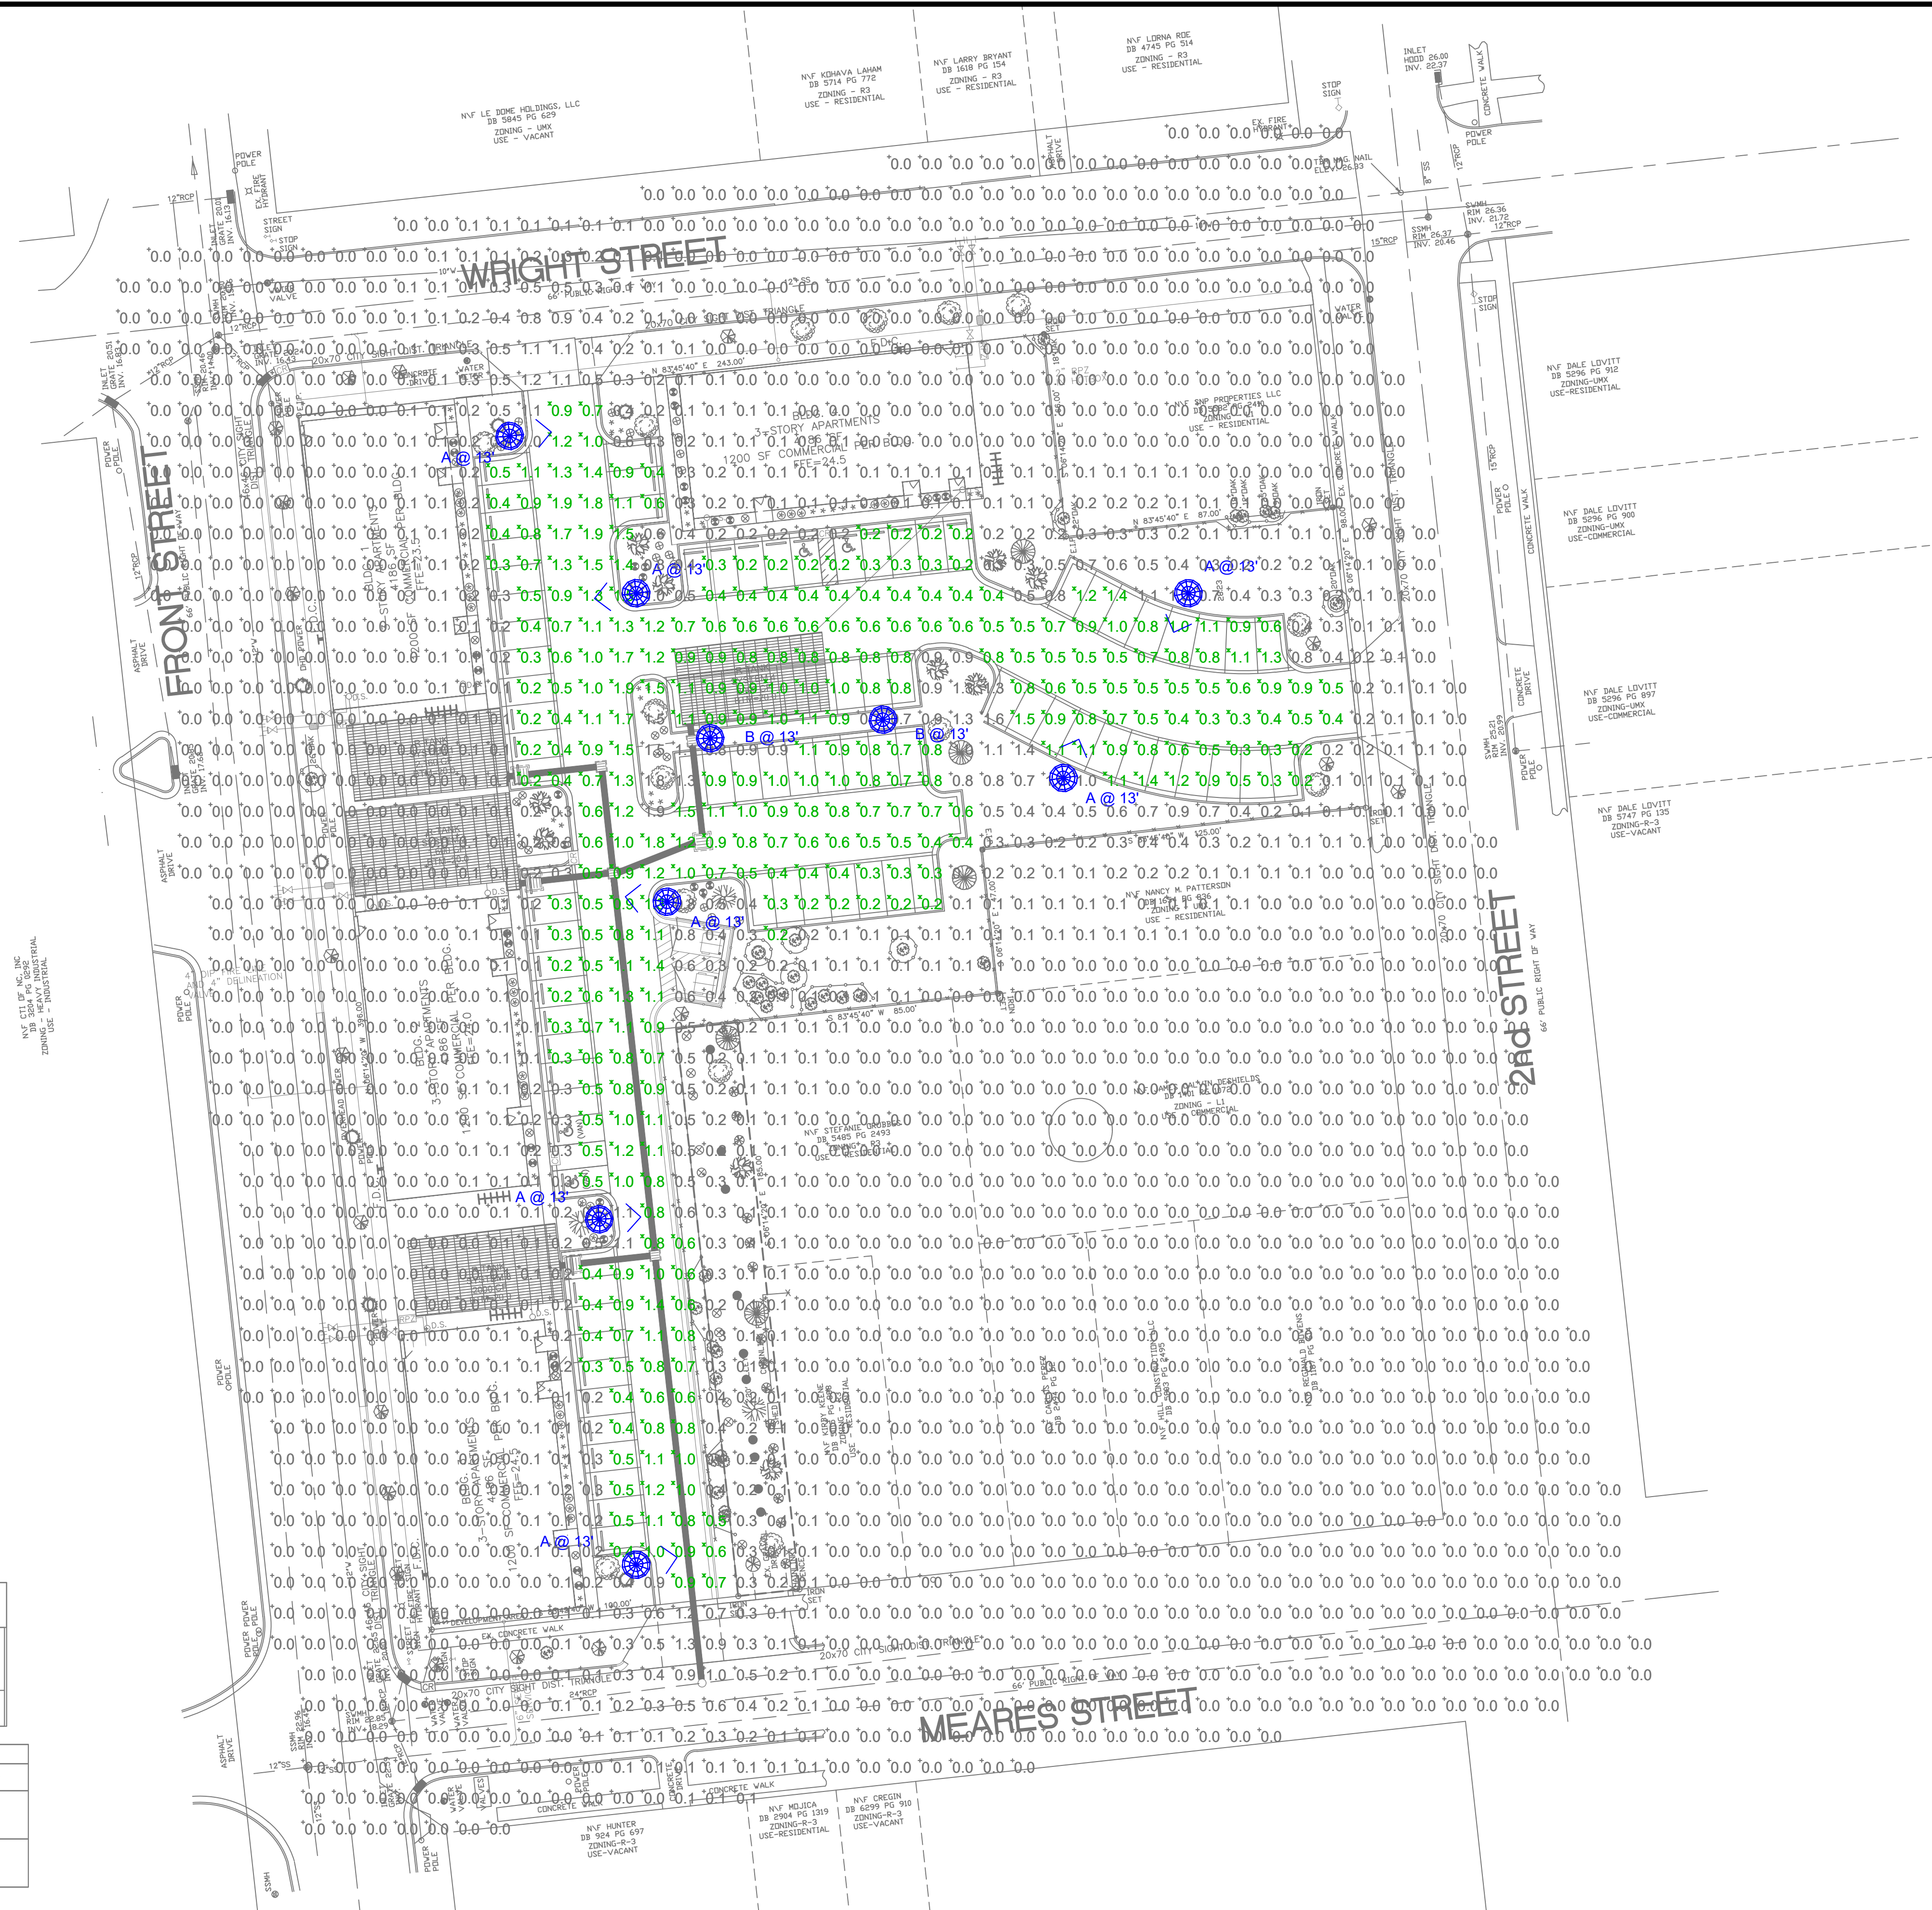

**ISDFOOTCANDLE CURVES**

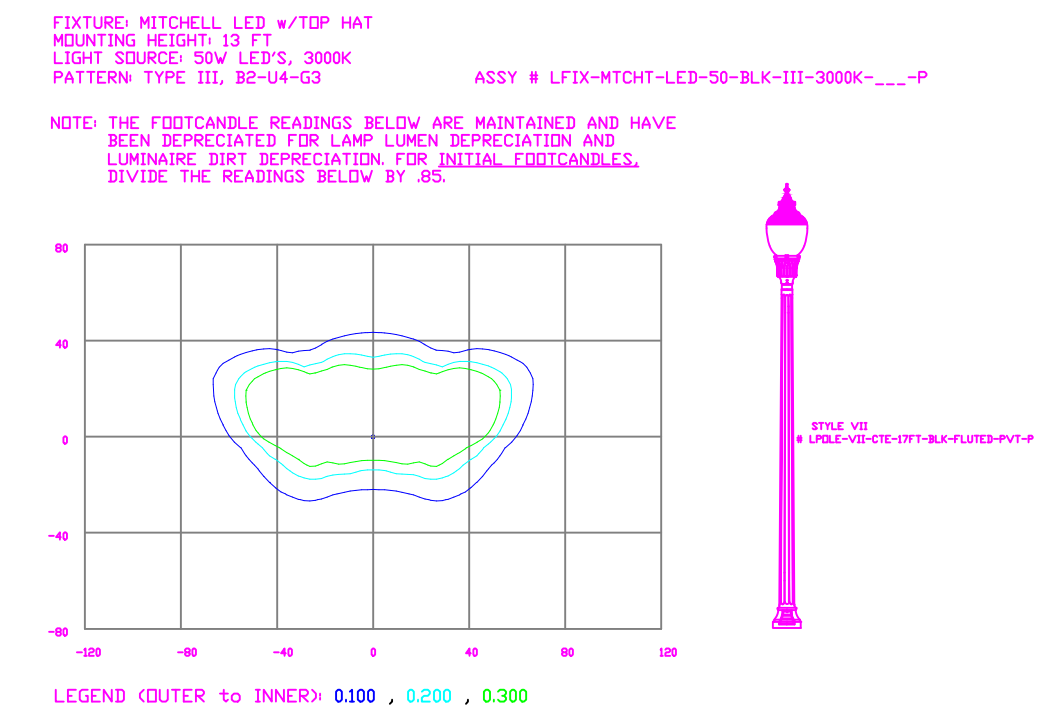

**ISDFOOTCANDLE CURVES**

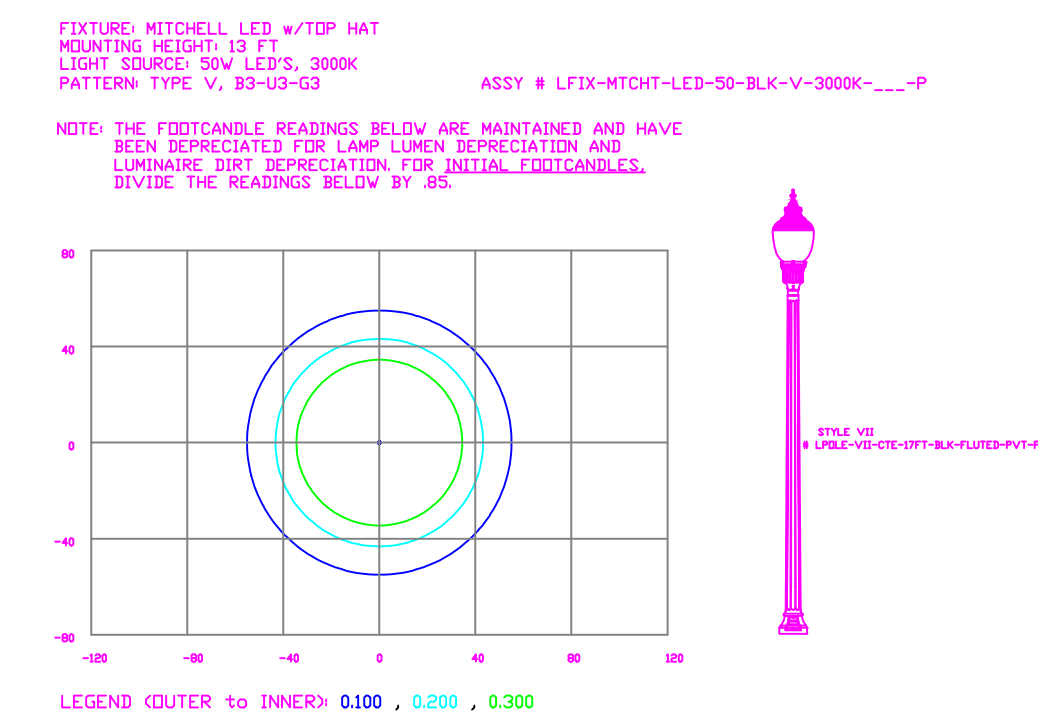


Statistics						
Description	Symbol	Avg	Max	Min	Max/Min	Avg/Min
Parking	✕	0.7 fc	1.9 fc	0.2 fc	9.5:1	3.5:1

Schedule						
Symbol	Label	Quantity	Description	Number Lamps	Lumens Per Lamp	Light Loss Factor
⬆	A	7	LED 50w Mitchell Top Hat - Type III - 3000K	1	6133	0.85
⬆	B	2	LED 50w Mitchell Top Hat - Type V - 3000K	1	6209	0.85

**LIGHTING DESIGN TOLERANCE**

The calculated footcandle light levels in this lighting design are predicted values and are based on specific information that has been supplied to Duke Energy. Any inaccuracies in the supplied information, differences in luminaire installation, lighted area geometry including elevation differences, reflective properties of surrounding surfaces, obstructions (foliage or structures) in the lighted area, or lighting from sources other than listed in this design may produce different results from the predicted values. Normal tolerances of voltage, lamp output, and ballast and luminaire manufacture will also affect results.

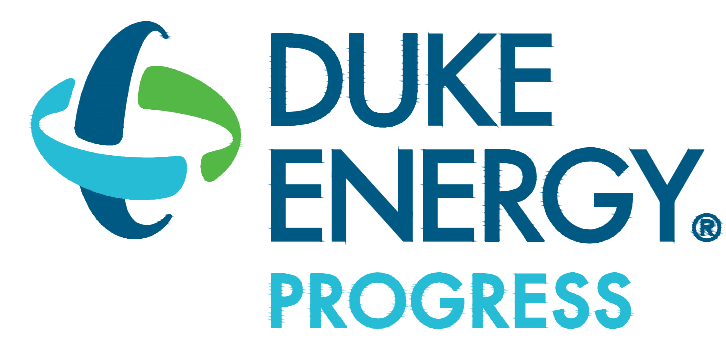

**PROPRIETARY & CONFIDENTIAL**

This document together with the concepts and designs presented herein, presented as an instrument of service, is the sole property of Duke Energy, and is intended only for the specific purpose and prospective client as stated in the title block of this drawing. Any use, copying, reproduction or disclosure of the drawing, design or any information contained herein by the prospective customer or other entities, including without limitation, architects, engineers, or equipment manufacturers is hereby expressly prohibited and shall not be permitted absent prior written consent from, and payment of compensation to Duke Energy. Duke Energy disclaims any liability or responsibility for any unauthorized use of or reliance on this document.

**THE BLOCK APARTMENTS**

Wilmington, NC  
 SITE LIGHTING PLAN  
 Designed by DEP LIGHTING SOLUTIONS  
 Reviewed by N. Johnson Scale 1" = 30'  
 Date 07/07/2022 Size Arch D  
 Description LED Mitchell Top Hat - Style VII Pole  
 Drawing No. 22-0276A Sht. 1 OF 1

REV#	DATE	REVISION	BY
Rev A	07/07/22	Mitchell Top Hat - 3000K - Style VII Pole	NJ

Customer approval	Date